Village of Beecher

625 Dixie Highway PO Box 1154 Beecher, Illinois 60401 Phone: 708-946-2261 Fay: 708-946-3764

Fax: 708-946-3764 www.villageofbeecher.org



Marcy Meyer
Clerk
Janett McCawley
Administrator
Charity Mitchell
Treasurer
Donna Rooney

President

Trustees
Todd Kraus
Joe Tieri
Roger Stacey
Erik Gardner
David Weissbohn

REGULAR MEETING OF THE PRESIDENT AND BOARD OF TRUSTEES
MONDAY, AUGUST 26, 2024 AT 7:00 PM
BEECHER VILLAGE HALL
625 DIXIE HIGHWAY

AGENDA

- I. PLEDGE OF ALLEGIANCE
- II. ROLL CALL
- III. APPROVAL OF MINUTES OF THE PREVIOUS MEETING
- IV. RECOGNITION OF AUDIENCE
- V. VILLAGE CLERK'S REPORT
- VI. VILLAGE PRESIDENT'S REPORT
 - 1. APPOINTMENT OF ROBERT BARBER TO THE PLANNING & ZONING COMMISSION.
- VII. COMMITTEE REPORTS
- A. FINANCE AND ADMINISTRATION COMMITTEE Todd Kraus, Chair & David Weissbohn
 - 1. CONSIDER A MOTION APPROVING THE LIST OF BILLS AND PAYROLL.
- B. PUBLIC BUILDINGS AND PROPERTIES, PARKS AND RECREATION COMMITTEE Todd Kraus, Co-Chair
- C. PLANNING, BUILDING AND ZONING COMMITTEE Erik Gardner, Chair & Joe Tieri
 - 1. CONSIDER A REQUEST FROM LENNAR HOMES TO MAKE PROPOSED CHANGES TO THE PLANNED UNIT DEVELOPMENT ORDINANCE THAT INCLUDES THE HUNTER'S CHASE EAST SUBDIVISION. Representatives from Lennar Homes will be in attendance.
 - 2. CONSIDER A MOTION TO SUBMIT A LETTER OF OBJECTION TO THE WILL COUNTY LAND USE DEPARTMENT FOR A SPECIAL USE PERMIT FOR THE CONSTRUCTION OF A COMMUNITY SOLAR GARDEN / COMMERCIAL FACILITY LOCATED ON SOUTH PARK ROAD. THE PROJECT SIZE IS APPROXIMATELY 35.8 ACRES. Since the project is within 1.5 miles of Beecher Village limits, the Village Board can submit a letter of objection or non-objection to be considered by the County Board. The PZC discussed the project at their

- meeting on August 22, 2024 and voted unanimously to recommend that the village board object to the project.
- 3. CONSIDER AN ORDINANCE GRANTING A SPECIAL USE PERMIT FOR 759 W. INDIANA AVENUE UNDER THE ZONING ORDINANCE OF THE VILLAGE OF BEECHER TO ALLOW A U-HAUL RENTAL BUSINESS IN A B-1 HISTORIC DOWNTOWN DISTRICT.
- 4. UPDATE ON ZONING ORDINANCE REVISION.
- 5. THE NEXT PLANNING AND ZONING COMMISSION MEETING IS SCHEDULED FOR THURSDAY, SEPTEMBER 26, 2024 AT 7:00 PM.

D. PUBLIC SAFETY COMMITTEE - Joe Tieri, Chair & Roger Stacey

1. CONSIDER A MOTION AUTHORIZING THE CHIEF OF POLICE TO SIGN A MEMORANDUM OF UNDERSTANDING WITH THE VILLAGE OF MONEE TO PROVIDE PROTECTIVE PERSONNEL AND EQUIPMENT TO MONEE IN RELATION TO THEIR FUNCTION AS A MUNICIPAL POLICE FORCE.

E. PUBLIC WORKS COMMITTEE - Roger Stacey, Chair & Erik Gardner

1. CONSIDER A MOTION TO ACCEPT THE BID FROM K.R.T. CONCRETE IN THE AMOUNT OF \$21,600.00 FOR SIDEWALK REPLACEMENT AS SPECIFIED IN THE RFP. This was the lowest bid.

F. ECONOMIC DEVELOPMENT AND COMMUNITY RELATIONS COMMITTEE

- David Wiessbohn Chair
- 1. CONCERT IN THE PARK. Reminder that the last concert of the year is September 7 from 7 PM to 9:30 PM. The band is Rearview (Pearl Jam Tribute).
- G. OLD BUSINESS
- H. ADJOURN TO EXECUTIVE SESSION if necessary.
- I. NEW BUSINESS
- J. ADJOURNMENT

MINUTES OF THE REGULAR MEETING OF THE PRESIDENT & BOARD OF TRUSTEES OF THE VILLAGE OF BEECHER HELD AT THE BEECHER VILLAGE HALL, 625 DIXIE HIGHWAY, BEECHER, ILLINOIS AUGUST 12, 2024 -- 7:00 P.M.

All present joined in the Pledge to the Flag.

President Meyer called the meeting to order.

ROLL CALL

PRESENT: President Meyer and Trustees Stacey, Tieri, Kraus, Gardner and Weissbohn.

ABSENT: None.

STAFF PRESENT: Clerk Janett McCawley, Administrator Charity Mitchell, Public Works Superintendent Matt Conner, Chief Terry Lemming, Treasurer Donna Rooney and EMA Director Bob Heim.

GUESTS: George Schuitema, Vic Reato, and two representatives from U-Haul.

APPROVAL OF MINUTES

President Meyer asked for consideration of the minutes of the July 22, 2024 Board meeting. Trustee Tieri made a motion to approve the minutes as written. Trustee Weissbohn seconded.

AYES: (5) Trustees Stacey, Tieri, Kraus, Gardner and Weissbohn.

NAYS: (0) None.

Motion carried.

RECOGNITION OF AUDIENCE – None.

VILLAGE CLERK REPORT

- 1) A report was provided on tax income received in July, 2024.
- 2) Election packets will be available beginning August 20th.
- 3) There were no objections to the Knights of Columbus request to hold their Annual Intellectual Disabilities fund drive in Beecher from September 13-15, 2024.

<u>VILLAGE PRESIDENT REPORT</u> – None.

REPORTS OF VILLAGE COMMISSIONS

Trustee Kraus provided a 4^{th} of July Commission report. The next meeting is scheduled for August 19^{th} at 6:30 p.m.

Trustee Weissbohn provided a Youth Commission report. The next meeting is scheduled for August 20th.

Trustee Gardner provided a Historic Preservation Commission report. The next meeting is scheduled for August 21st.

<u>PLANNING, BUILDING AND ZONING COMMITTEE</u> - (out of agenda order)

The Board discussed a special use permit request for a U-Haul rental business at 759 Indiana Avenue as considered by the Planning and Zoning Commission (PZC). The PZC voted unanimously to recommend approval of the special use permit request with the following conditions: No more than four trucks on the property and the one truck parked in front must be operable and be occasionally moved. The petitioner, Vic Reato, explained his plan and representatives from U-Haul were also present to answer questions. President Meyer received a private message from a resident in the area that opposed the permit. One resident attended the PZC meeting and asked questions but did not speak in opposition. All rentals will be handled on-site. This is in addition to his current business. He will be an authorized dealer, not an owner. Trustee Gardner made a motion to authorize attorney to draft an Ordinance granting a special use permit in a B-1 Historic Downtown Business District for a U-Haul rental business at 759 W. Indiana Avenue. Trustee Weissbohn seconded.

AYES: (5) Trustees Stacey, Tieri, Kraus, Gardner and Weissbohn.

NAYS: (0) None.

Motion carried.

The Building Department monthly report was provided in the packet for review.

FINANCE AND ADMINISTRATION COMMITTEE

Trustee Kraus made a motion to approve the Treasurer's report. Treasurer Rooney was present and provided a report. Trustee Stacey seconded.

AYES: (5) Trustees Stacey, Tieri, Kraus, Gardner and Weissbohn.

NAYS: (0) None.

Motion carried.

Variance reports for the previous month were provided in the packet for review.

Trustee Kraus made a motion to approve payment of the list of bills in the amount of \$110,634.01 and payroll since the last meeting. Trustee Stacey seconded.

AYES: (5) Trustees Stacey, Tieri, Kraus, Gardner and Weissbohn.

NAYS: (0) None.

Motion carried.

PUBLIC BUILDINGS AND PROPERTIES, PARKS AND RECREATION COMMITTEE

The Board discussed a date for the Holiday Tree Lighting. The event is tentatively scheduled for Sunday, December 1st.

PUBLIC SAFETY COMMITTEE

The Police Department, EMA and Code Enforcement monthly reports were provided in the packet for review.

An update was provided on the Laraway Communications Center Board of Directors meeting held on July 25th. A snapshot of the performance and director's report was provided to the Board members for review. The LCC Board found money left in the reserve fund and will issue rebates to members of the LCC communities to help offset fee increases.

Chief Lemming provided a report on the results of the National Night Out. The event went well and was well attended. A thank you letter was provided to participants.

PUBLIC WORKS COMMITTEE

Trustee Stacey made a motion to accept an updated proposal from Wirkus Paving to replace the parking lot and roadway at the Village Hall in the amount of \$52,501. Trustee Gardner seconded. This project was previously approved at the June 10, 2024 Village Board meeting. This will be paid out of Infrastructure funds until reimbursed by grant. Work is scheduled for week of August 26th.

AYES: (5) Trustees Stacey, Tieri, Kraus, Gardner and Weissbohn.

NAYS: (0) None.

Motion carried.

ECONOMIC DEVELOPMENT AND COMMUNITY RELATIONS COMMITTEE

Trustee Weissbohn provided an update on the concert in the park held on Saturday. The concert was the most well-attended of all concerts so far. The last concert of the year will be held on September 7th from 7 p.m. to 9:30 p.m. The band is Rearview (Pearl Jam tribute).

OLD BUSINESS

An update was provided on revision to CESFA ordinance. Trustee Kraus said his schedule hasn't allowed him to meet with the Administrator and work out details. He hopes to get this done soon.

Trustee Kraus thanked staff for putting pictures on Facebook of police facility progress.

There being no further business to discuss in regular session, Trustee Tieri made a motion to adjourn into Executive Session at 7:23 p.m. to discuss personnel and pending litigation. Trustee Weissbohn seconded.

AYES: (5) Trustees Stacey, Tieri, Kraus, Gardner and Weissbohn.

NAYS: (0) None.

Motion carried.

Trustee Stacey made a motion to return to regular session at 7:47 p.m. Trustee Weissbohn seconded.

AYES: (5) Trustees Stacey, Tieri, Kraus, Gardner and Weissbohn.

NAYS: (0) None. Motion carried.

NEW BUSINESS

Administrator Mitchell said she and Clerk McCawley have been looking into ordinances to regulate Airbnb's and VRBO's since a complaint was received from a resident recently about a home rented out as an Airbnb next door to him.

Staff is looking at requirements for 60% of front facing brick on a house in Hunter's Chase East as required in the P.U.D. agreement. Requirements need to be clarified, as well as enforcement of the requirements.

There being no further business, President Meyer asked for a motion to adjourn. Trustee Gardner made a motion to adjourn the meeting. Trustee Weissbohn seconded.

AYES: (5) Trustees Stacey, Tieri, Kraus, Gardner and Weissbohn.

NAYS: (0) None. Motion carried.

Meeting adjourned at 7:57 p.m.

Respectfully submitted by:

Janett McCawley
Village Clerk



30200 Town Center Rd Beecher, IL 60401

Supervisor Michael Stanula

Assessor Pat Peters

Highway CommissionerMichael Smith

ClerkJoe Burgess

Trustees
Tracy Heldt
Teresa Peterson
George Obrdavich
Mark Herlitz

August 16, 2024

Beecher Plan Commission

Solar Garden

Re: Proposed Development – Wild Cat Solar 4 LLC, Siciliano Community

Dear Commissioners

The following letter shall address the Washington Township Board of Trustees' concerns regarding the zoning case.

We do not recommend the Zoning request nor the Special Use Variances for a Solar Farm. We are familiar with so called "Solar Farms". They continue to scar the landscape, replacing farmland which benefit our residents both regionally as well as nationally. Solar Farms benefit a select few and provide large profits to the developers. The long-term effects of solar farms have yet to be seen. The present effects we do know include migratory bird and wildlife disruption, loss of crop land and un-natural soil warming. Many components of the solar panels are also not recyclable once the life cycle of the equipment has ended. The longevity of the start-up solar developers to provide long term service and restoration of the property back to original ground is yet to be seen.

Solar Farm developers believe that if they put their projects out in the country no one will notice. We as a township do indeed notice, however we have our hands tied, due to state legislation, which limits our control over wind and solar energy projects, the best that we can do is to state our point of view and make recommendations.

The Siciliano Community Solar Garden (it's not a garden) project as proposed is to be in Beechers' backyard. Hopefully the residents of Nantucket Cove will notice.


I have attached the last two correspondence letters sent to Will County Planning expressing our concerns over recent solar projects. Once a case number has been assigned to this project, I will do the same.

Michael Stanula- Washington Township Supervisor

Cc: Village of Beecher Board of Trustees

Judy Ogalla, Chairman of the Will County Board

SICILIANO COMMUNITY SOLAR GARDEN

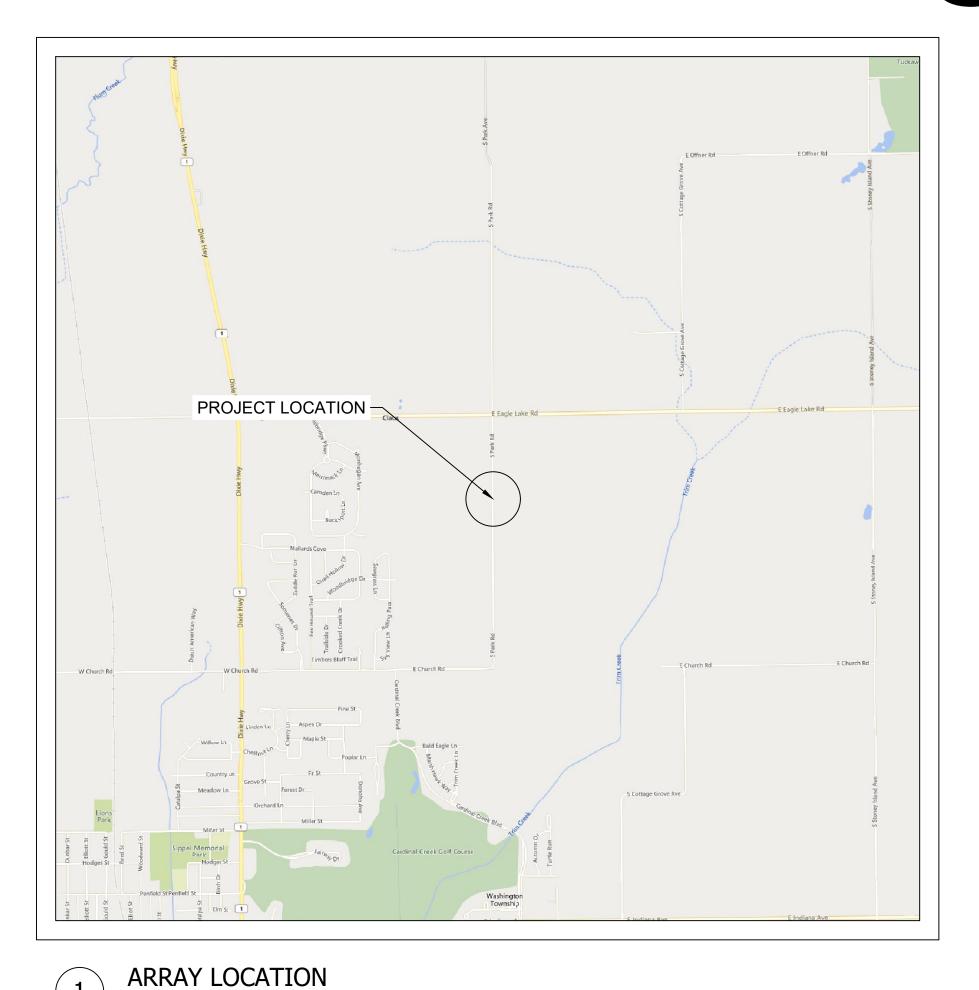



Scale: 1" = 300'

OVERHEAD MAP

PROJECT TEAM PROJECT OWNER WILD CAT SOLAR 4 LLC - SICILIANO 2530 RIVA RD SUITE 200 ANNAPOLIS, MD 21401 443-267-5012

PROJECT DEVELOPER **NEW ENERGY EQUITY** 2530 RIVA RD SUITE 200 ANNAPOLIS, MD 21401 443-267-5012

EPC CONTRACTOR

Scale: 1" = 2000'

GENERAL INFO

PROJECT ACREAGE **ENTIRE PARCEL AREA: 120.66 ACRES** FENCE ACREAGE: 26.53 ACRES LOT COVERAGE: 7.92% (AREA OF MODULES, ROAD & EQUIPMENT PADS DIVIDED BY PARCEL AREA) FACILITY AREA ACREAGE: 35.8 ACRES

PARCEL DESCRIPTION LAND OWNER: JAMES SICILIANO PARCEL ID NUMBER: 2222101000050000

SHEET INDEX

SHEET#	DESCRIPTION	REVISION #	REVISION DATE
T1	TITLE PAGE	1	5/15/2024
PV1	EXISTING CONDITIONS	1	5/15/2024
PV2A	SITE PLAN A	1	5/15/2024
PV2B	SITE PLAN B	1	5/15/2024
PV3	PID & ZONING MAP	1	5/15/2024
PV4	SOIL MAP	1	5/15/2024
PV5	TOPOGRAPHY & DRAINAGE	1	5/15/2024
PV6	CONSTURCTION & MAINTENANCE ROUTES	1	5/15/2024
PV7	RACKING DETAIL	1	5/15/2024
PV8	FENCE DETAIL	1	5/15/2024
PV9	STORMWATER BASIN DETAIL	1	5/15/2024
E1A	SINGLE LINE DIAGRAM 1	1	5/15/2024
E1B	SINGLE LINE DIAGRAM 2	1	5/15/2024
E2A	SYSTEM LABELS 1	1	5/15/2024
E2B	SYSTEM LABELS 2	1	5/15/2024
E3	INTERCONNECTION DETAIL	1	5/15/2024
E4	EQUIPMENT DOCS 1	1	5/15/2024
E5	EQUIPMENT DOCS 2	1	5/15/2024
E6	EQUIPMENT DOCS 3	1	5/15/2024
	T1 PV1 PV2A PV2B PV3 PV4 PV5 PV6 PV7 PV8 PV9 E1A E1B E2A E2B E3 E4 E5	T1 TITLE PAGE PV1 EXISTING CONDITIONS PV2A SITE PLAN A PV2B SITE PLAN B PV3 PID & ZONING MAP PV4 SOIL MAP PV5 TOPOGRAPHY & DRAINAGE PV6 CONSTURCTION & MAINTENANCE ROUTES PV7 RACKING DETAIL PV8 FENCE DETAIL PV9 STORMWATER BASIN DETAIL E1A SINGLE LINE DIAGRAM 1 E1B SINGLE LINE DIAGRAM 2 E2A SYSTEM LABELS 1 E2B SYSTEM LABELS 2 E3 INTERCONNECTION DETAIL E4 EQUIPMENT DOCS 2	T1 TITLE PAGE 1 PV1 EXISTING CONDITIONS 1 PV2A SITE PLAN A 1 PV2B SITE PLAN B 1 PV3 PID & ZONING MAP 1 PV4 SOIL MAP 1 PV5 TOPOGRAPHY & DRAINAGE 1 PV6 CONSTURCTION & MAINTENANCE ROUTES 1 PV7 RACKING DETAIL 1 PV8 FENCE DETAIL 1 PV9 STORMWATER BASIN DETAIL 1 E1A SINGLE LINE DIAGRAM 1 1 E1B SINGLE LINE DIAGRAM 2 1 E2A SYSTEM LABELS 1 1 E2B SYSTEM LABELS 2 1 E3 INTERCONNECTION DETAIL 1 E4 EQUIPMENT DOCS 1 1 E5 EQUIPMENT DOCS 2 1



NEWENERGYEQUITY.COM

PROJECT ADDRESS 28964 S PARK AVE BEECHER, IL 60401

LAT: 41.365 LONG: -87.602

SPECIFICATIONS	SYSTEM
7.378 MW	SYSTEM SIZE DC
POWER LIMITED TO 5.000 MW	SYSTEM SIZE AC
1.476	DC/AC RATIO
180°	AZIMUTH
+/- 52°	TILT
12720	MODULE COUNT
HANWHA Q.PEAK DUO XL-G11.3/BFG	MODULE TYPE
580 W	MODULE STC RATING
34	INVERTER COUNT
SMA SUNNY HIGHPOWER PEAK- 150kW	INVERTER TYPE
POWER LIMITED TO 147.058 kW	INVERTER POWER
TBD	RACKING
ALSO ENERGY	MONITORING

DESIGN CRITERIA		
MIN/MAX TEMP.	-22°C / 33°C	
WIND SPEED (ASCE 7-10)	105 MPH	
BUILDING CATEGORY	1	
EXPOSURE CATEGORY	С	
GROUND SNOW LOAD	25 PSF	
BUILDING HEIGHT	0'-0"	
	MIN/MAX TEMP. WIND SPEED (ASCE 7-10) BUILDING CATEGORY EXPOSURE CATEGORY GROUND SNOW LOAD	

SERVICE LINES OR OTHER UTILITIES IN

24/7 UNESCORTED KEYLESS ACCESS PROVIDED FOR ALL UTILITY ENERGY **EQUIPMENT INCLUDING THE METERS AND** AC DISCONNECT.

INTERCONNECTION TYPE: PRIMARY

	REVISIONS		
#	DESCRIPTION	BY	DAT
0	ORIGINAL DESIGN	SP	3/20/20
1	CUP PACKAGE	SP	3/22/20
2	ACCESS RD CHANGE	SP	4/5/20
3	1.55 DC/AC RATIO CHANGE	SP	12/7/20
4	SLD WYE-DELTA WYE	SP	3/14/20
5	CUP REFRESH	SP	4/30/2
6	GAS LINE ADDITION	SP	5/9/20
7	VISUAL SCREENING PAGES	SP	5/28/20
8			
9			
10			
11			

PROJECT NAME SICILIANO

DRAWING TITLE

TITLE SHEET

SHEET





NEW ENERGY EQUITY, LLC 2530 RIVA ROAD, SUITE 200 ANNAPOLIS, MD 21041 NEWENERGYEQUITY.COM 443-267-5012

PROJECT ADDRESS 28964 S PARK AVE BEECHER, IL 60401

LAT: 41.365 LONG: -87.602

SPECIFICATIONS	SYSTEM
7.378 MW	SYSTEM SIZE DC
POWER LIMITED TO 5.000 MW	SYSTEM SIZE AC
1.476	DC/AC RATIO
180°	AZIMUTH
+/- 52°	TILT
12720	MODULE COUNT
HANWHA Q.PEAK DUO XL-G11.3/BFG	MODULE TYPE
580 W	MODULE STC RATING
34	INVERTER COUNT
SMA SUNNY HIGHPOWER PEAK 150kW	INVERTER TYPE
POWER LIMITED TO 147.058 kV	INVERTER POWER
TBD	RACKING
ALSO ENERGY	MONITORING

MIN/MAX TEMP22°C / 33°C WIND SPEED (ASCE 7-10) 105 MPH	DESIGN CRITERIA				
WIND SPEED (ASCE 7-10) 105 MPH					
(
BUILDING CATEGORY I					
EXPOSURE CATEGORY C					
GROUND SNOW LOAD 25 PSF					
BUILDING HEIGHT 0'-0"					

OTHER NOTES E-911 ADDRESS TO BE APPLIED FOR WITH BUILDING PERMIT

NO POSITION, DISTANCE, OR CLEARANCE ISSUES WITH OVERHEAD ELECTRIC SERVICE LINES OR OTHER UTILITIES IN RELATION TO THE PV PANELS.

24/7 UNESCORTED KEYLESS ACCESS PROVIDED FOR ALL UTILITY ENERGY
EQUIPMENT INCLUDING THE METERS AND
AC DISCONNECT.

INTERCONNECTION TYPE: PRIMARY

REVISIONS				
#	DESCRIPTION	BY	DATE	
0	ORIGINAL DESIGN	SP	3/20/2023	
1	CUP PACKAGE	SP	3/22/2023	
2	ACCESS RD CHANGE	SP	4/5/2023	
3	1.55 DC/AC RATIO CHANGE	SP	12/7/2023	
4	SLD WYE-DELTA WYE	SP	3/14/2024	
5	CUP REFRESH	SP	4/30/2024	
6	GAS LINE ADDITION	SP	5/9/2024	
7	VISUAL SCREENING PAGES	SP	5/28/2024	
8				
9				
10				
11				


PROJECT NAME SICILIANO

DRAWING TITLE

SITE PLAN

SCALE 1

SHEET

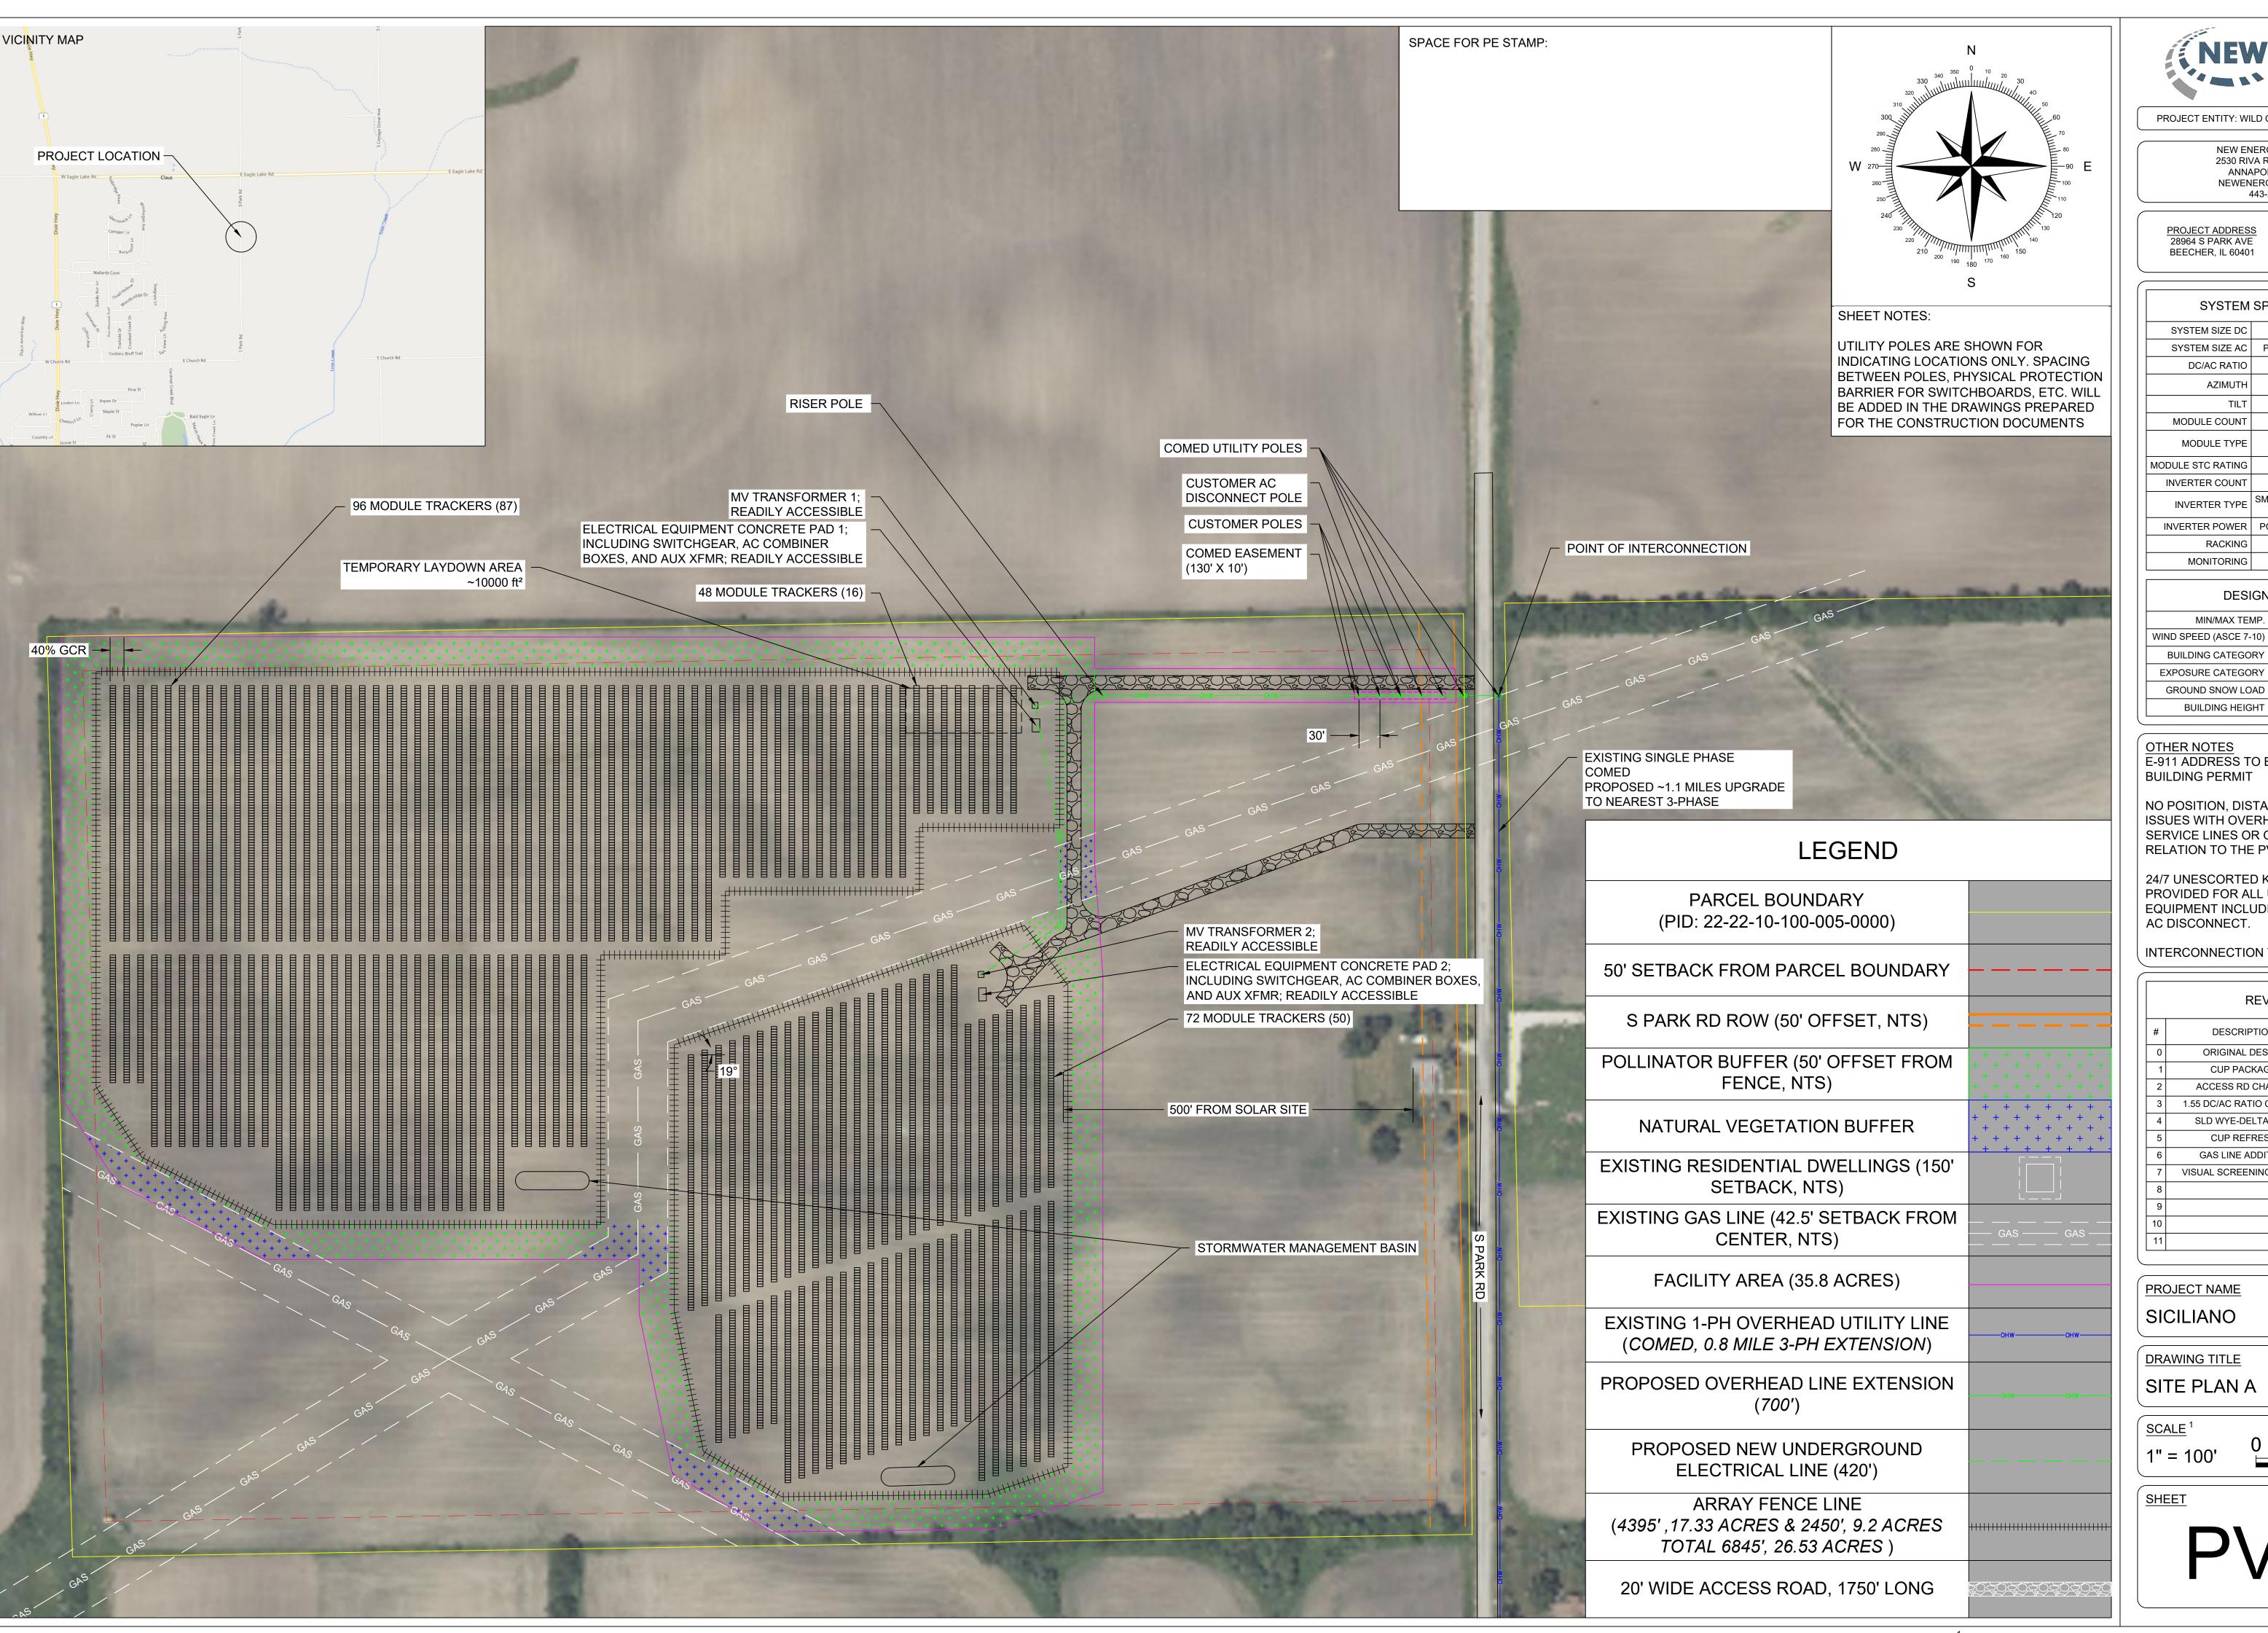



NEW ENERGY EQUITY, LLC 2530 RIVA ROAD, SUITE 200 ANNAPOLIS, MD 21041 NEWENERGYEQUITY.COM 443-267-5012

PROJECT ADDRESS 28964 S PARK AVE BEECHER, IL 60401

LAT: 41.365 LONG: -87.602

SYSTEM SIZE DC	7.378 MW			
SYSTEM SIZE AC	POWER LIMITED TO 5.000 MW			
DC/AC RATIO	1.476			
AZIMUTH 180°				
TILT	+/- 52°			
MODULE COUNT	12720			
MODULE TYPE	HANWHA Q.PEAK DUO XL-G11.3/BFG			
MODULE STC RATING 580 W				
INVERTER COUNT	34			
INVERTER TYPE SMA SUNNY HIGHPOWER PEAK-3 150kW				
INVERTER POWER POWER LIMITED TO 147.058 kW				
RACKING TBD				
MONITORING ALSO ENERGY				

OTHER NOTES E-911 ADDRESS TO BE APPLIED FOR WITH

-22°C / 33°C

105 MPH

25 PSF

0'-0"

MIN/MAX TEMP.

BUILDING CATEGORY EXPOSURE CATEGORY GROUND SNOW LOAD

BUILDING HEIGHT

NO POSITION, DISTANCE, OR CLEARANCE ISSUES WITH OVERHEAD ELECTRIC SERVICE LINES OR OTHER UTILITIES IN RELATION TO THE PV PANELS.

24/7 UNESCORTED KEYLESS ACCESS PROVIDED FOR ALL UTILITY ENERGY EQUIPMENT INCLUDING THE METERS AND AC DISCONNECT.

INTERCONNECTION TYPE: PRIMARY

	REVISIONS		
#	DESCRIPTION	BY	DATE
0	ORIGINAL DESIGN	SP	3/20/2023
1	CUP PACKAGE	SP	3/22/2023
2	ACCESS RD CHANGE	SP	4/5/2023
3	1.55 DC/AC RATIO CHANGE	SP	12/7/2023
4	SLD WYE-DELTA WYE	SP	3/14/2024
5	CUP REFRESH	SP	4/30/2024
6	GAS LINE ADDITION	SP	5/9/2024
7	VISUAL SCREENING PAGES	SP	5/28/2024
8			
9			
10			
11			

PROJECT NAME SICILIANO


DRAWING TITLE

SITE PLAN A

SCALE 1

SHEET

PV2A

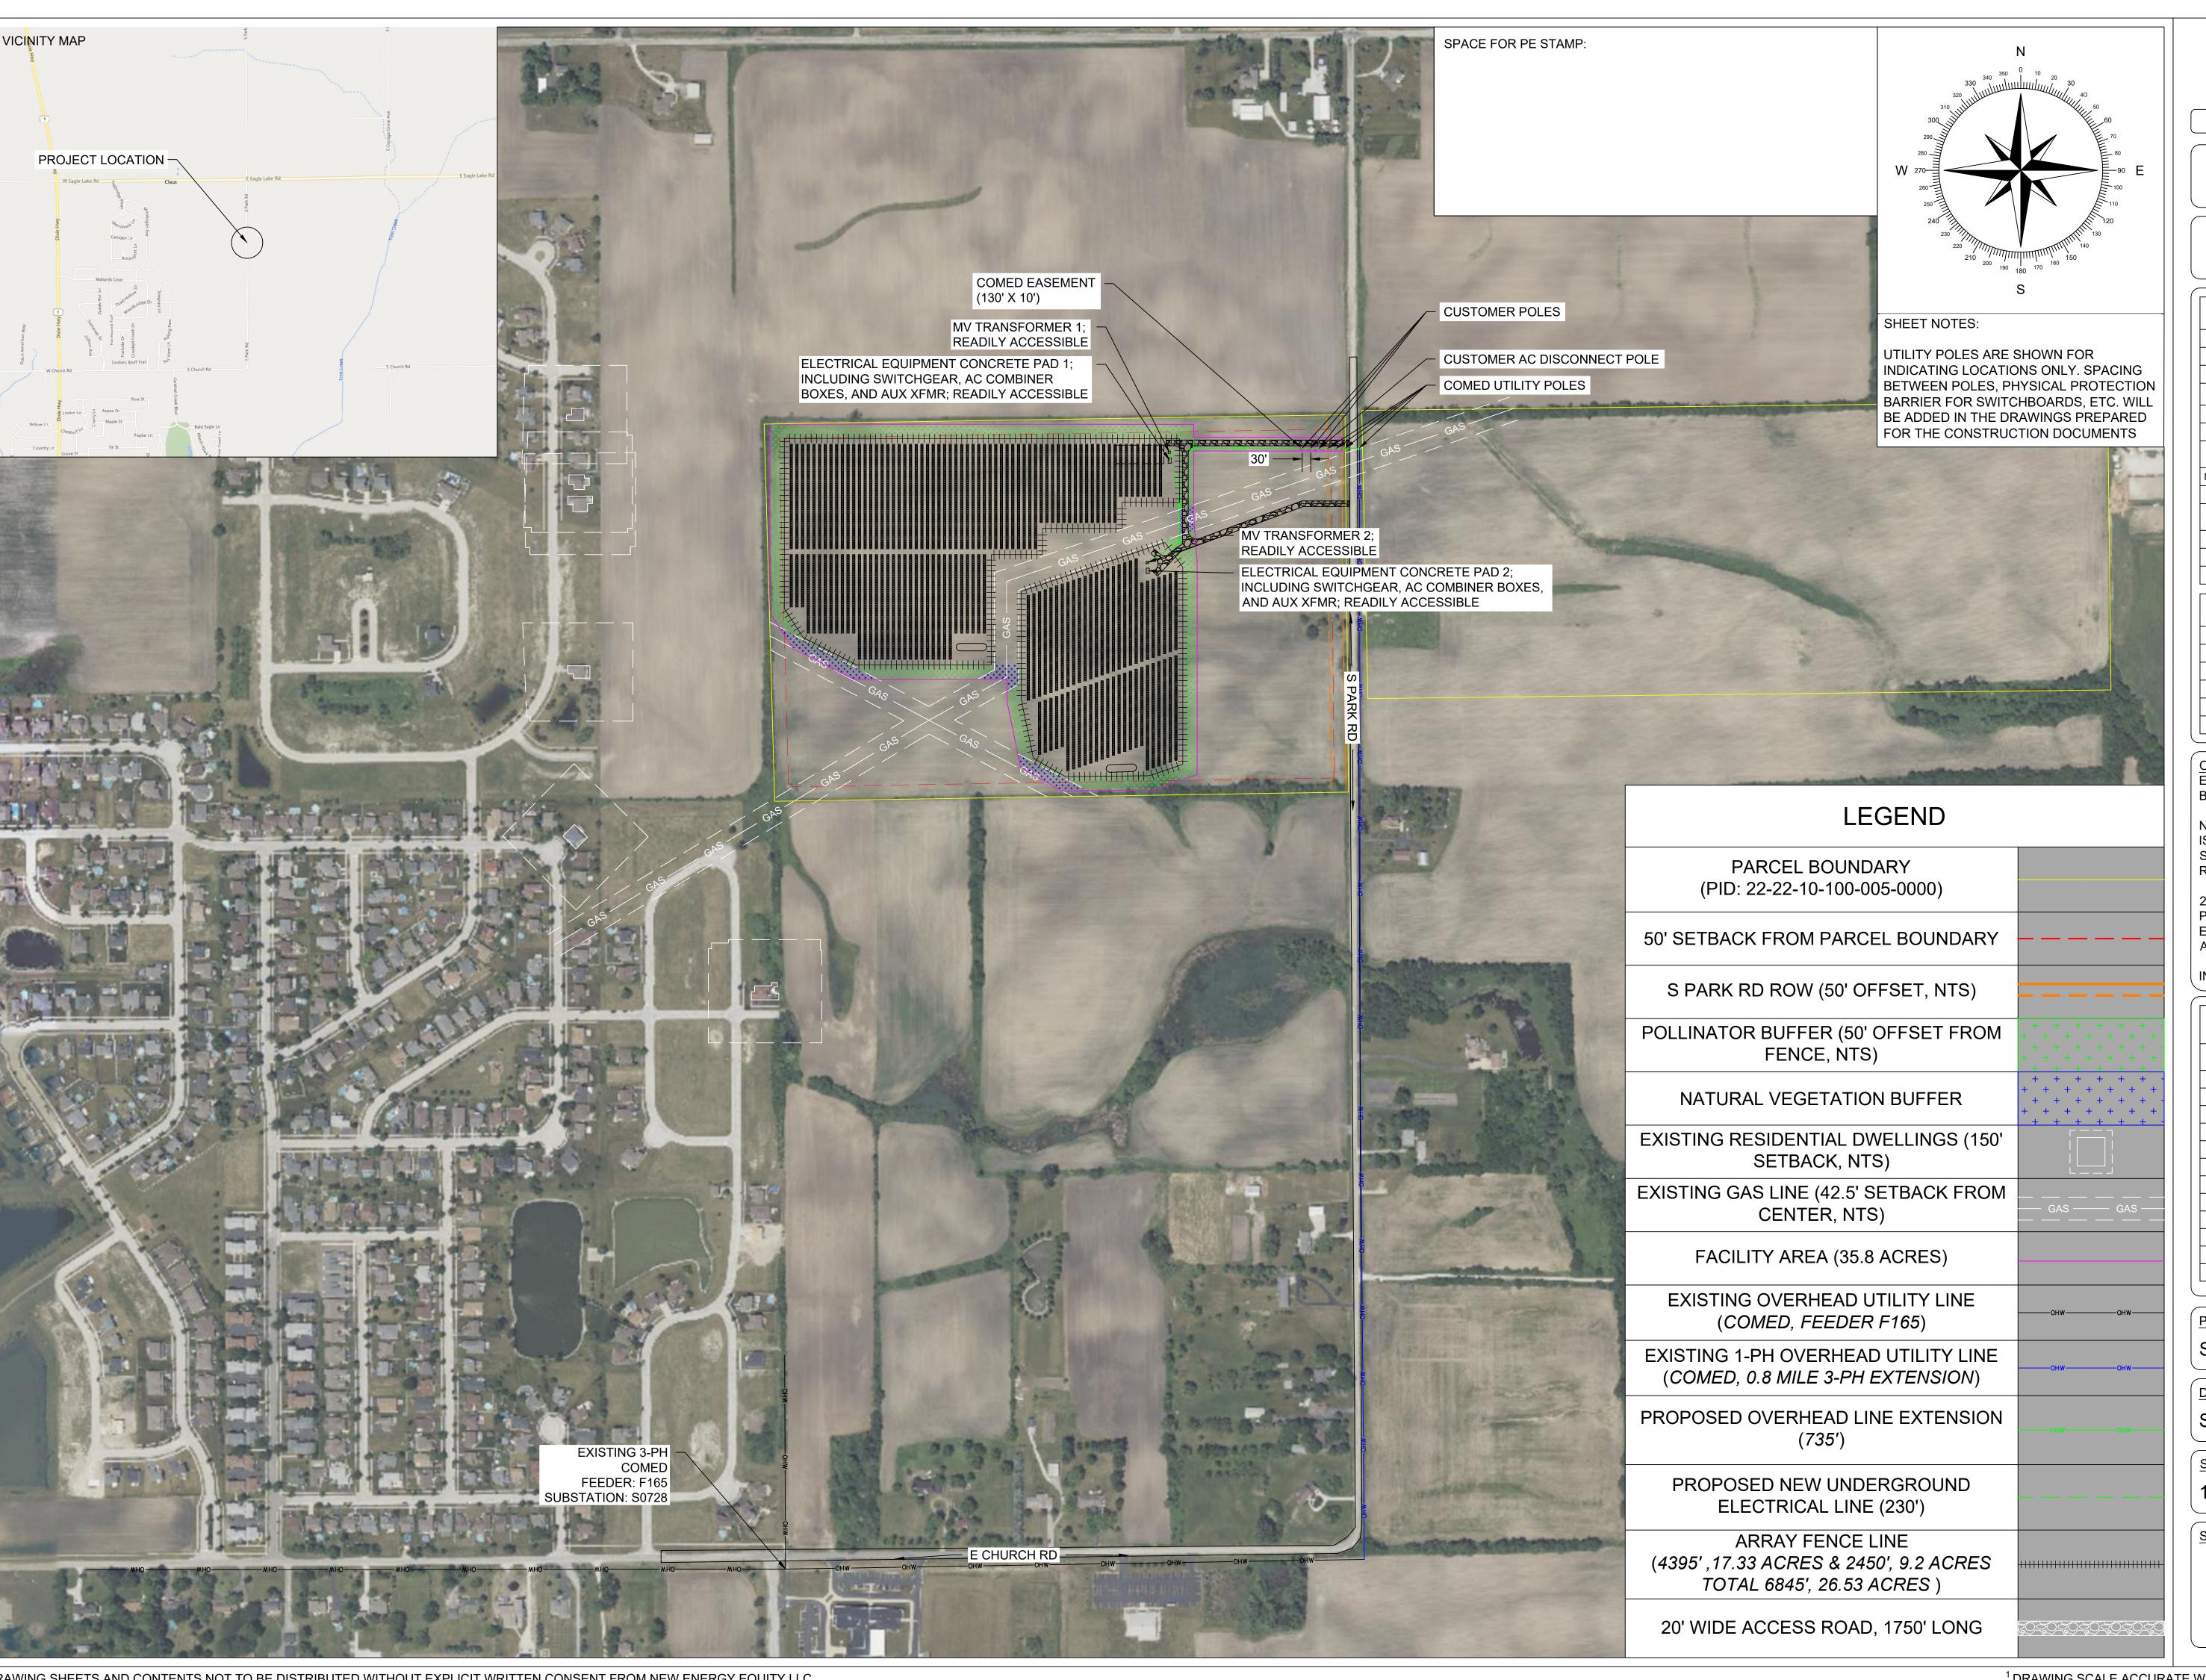



NEW ENERGY EQUITY, LLC 2530 RIVA ROAD, SUITE 200 ANNAPOLIS, MD 21041 NEWENERGYEQUITY.COM 443-267-5012

PROJECT ADDRESS 28964 S PARK AVE BEECHER, IL 60401

LAT: 41.365 LONG: -87.602

SYSTEM	SPECIFICATIONS
SYSTEM SIZE DC	7.378 MW
SYSTEM SIZE AC	POWER LIMITED TO 5.000 MW
DC/AC RATIO	1.476
AZIMUTH	180°
TILT	+/- 52°
MODULE COUNT	12720
MODULE TYPE	HANWHA Q.PEAK DUO XL-G11.3/BFG
MODULE STC RATING	580 W
INVERTER COUNT	34
INVERTER TYPE	SMA SUNNY HIGHPOWER PEAK-3 150kW
INVERTER POWER	POWER LIMITED TO 147.058 kW
RACKING	TBD
MONITORING	ALSO ENERGY

	DESIGN CRITERIA				
	MIN/MAX TEMP.	-22°C / 33°C			
	WIND SPEED (ASCE 7-10)	105 MPH			
	BUILDING CATEGORY	Ţ			
	EXPOSURE CATEGORY	С			
	GROUND SNOW LOAD	25 PSF			
	BUILDING HEIGHT	0'-0"			
(

OTHER NOTES E-911 ADDRESS TO BE APPLIED FOR WITH **BUILDING PERMIT**

NO POSITION, DISTANCE, OR CLEARANCE ISSUES WITH OVERHEAD ELECTRIC SERVICE LINES OR OTHER UTILITIES IN RELATION TO THE PV PANELS.

24/7 UNESCORTED KEYLESS ACCESS PROVIDED FOR ALL UTILITY ENERGY EQUIPMENT INCLUDING THE METERS AND AC DISCONNECT.

INTERCONNECTION TYPE: PRIMARY

	REVISIONS		
#	DESCRIPTION	BY	DATE
0	ORIGINAL DESIGN	SP	3/20/2023
1	CUP PACKAGE	SP	3/22/2023
2	ACCESS RD CHANGE	SP	4/5/2023
3	1.55 DC/AC RATIO CHANGE	SP	12/7/2023
4	SLD WYE-DELTA WYE	SP	3/14/2024
5	CUP REFRESH	SP	4/30/2024
6	GAS LINE ADDITION	SP	5/9/2024
7	VISUAL SCREENING PAGES	SP	5/28/2024
8			
9			
10			
11			

PROJECT NAME SICILIANO


DRAWING TITLE

SITE PLAN B

SCALE 1

SHEET

PV2B

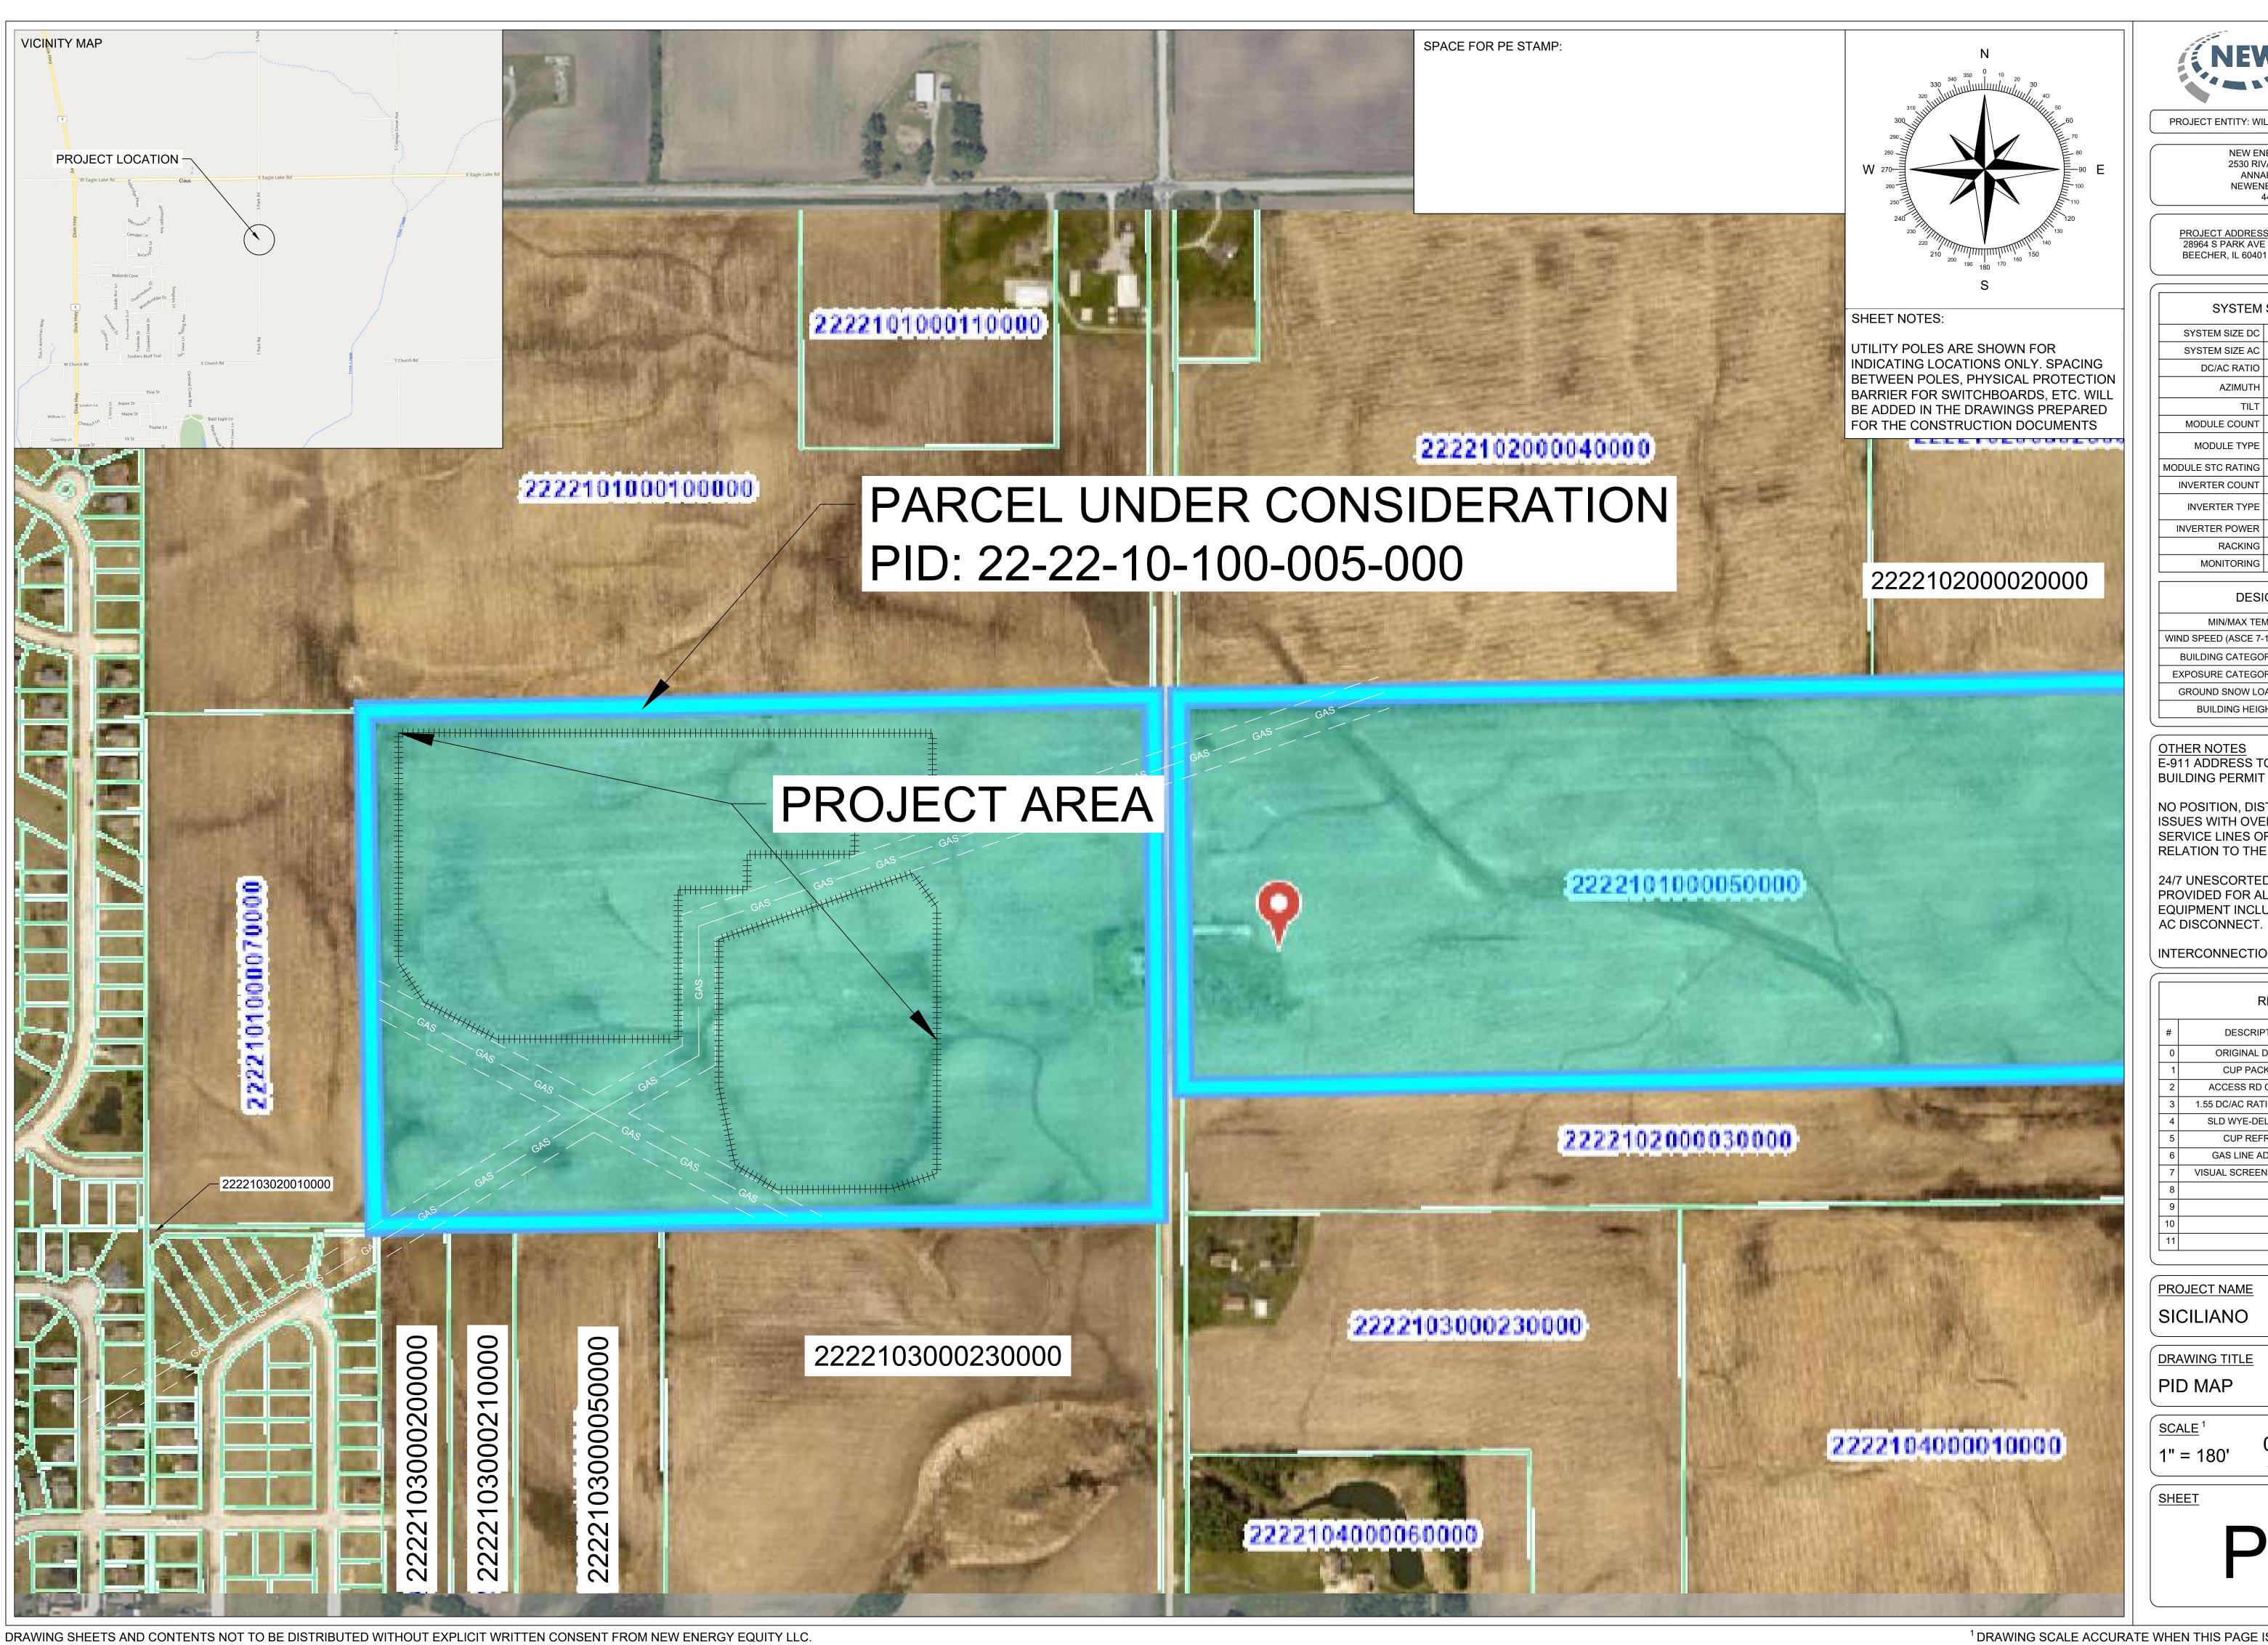

NEW ENERGY
EQUITY

NEWENERGYEQUITY.COM 443-267-5012

PROJECT ADDRESS 28964 S PARK AVE

LAT: 41.365 LONG: -87.602

SYSTEM SPECIFICATIONS			
SYSTEM SIZE DC	7.378 MW		
SYSTEM SIZE AC	POWER LIMITED TO 5.000 MW		
DC/AC RATIO	1.476		
AZIMUTH	180°		
TILT	+/- 52°		
MODULE COUNT	12720		
MODULE TYPE	HANWHA Q.PEAK DUO XL-G11.3/BFG		
MODULE STC RATING	580 W		
INVERTER COUNT	34		
INVERTER TYPE	SMA SUNNY HIGHPOWER PEAK-3 150kW		
INVERTER POWER	POWER LIMITED TO 147.058 kW		
RACKING	TBD		
MONITORING	ALSO ENERGY		

MIN/MAX TEMP22°C / 33°C WIND SPEED (ASCE 7-10) 105 MPH
WIND SPEED (ASCE 7-10) 105 MPH
BUILDING CATEGORY I
EXPOSURE CATEGORY C
GROUND SNOW LOAD 25 PSF
BUILDING HEIGHT 0'-0"

NO POSITION, DISTANCE, OR CLEARANCE ISSUES WITH OVERHEAD ELECTRIC SERVICE LINES OR OTHER UTILITIES IN RELATION TO THE PV PANELS.


24/7 UNESCORTED KEYLESS ACCESS PROVIDED FOR ALL UTILITY ENERGY EQUIPMENT INCLUDING THE METERS AND AC DISCONNECT.

INTERCONNECTION TYPE: PRIMARY

REVISIONS				
#	DESCRIPTION	BY	DATE	
0	ORIGINAL DESIGN	SP	3/20/2023	
1	CUP PACKAGE	SP	3/22/2023	
2	ACCESS RD CHANGE	SP	4/5/2023	
3	1.55 DC/AC RATIO CHANGE	SP	12/7/2023	
4	SLD WYE-DELTA WYE	SP	3/14/2024	
5	CUP REFRESH	SP	4/30/2024	
6	GAS LINE ADDITION	SP	5/9/2024	
7	VISUAL SCREENING PAGES	SP	5/28/2024	
8				
9				
10				
11				



PV3

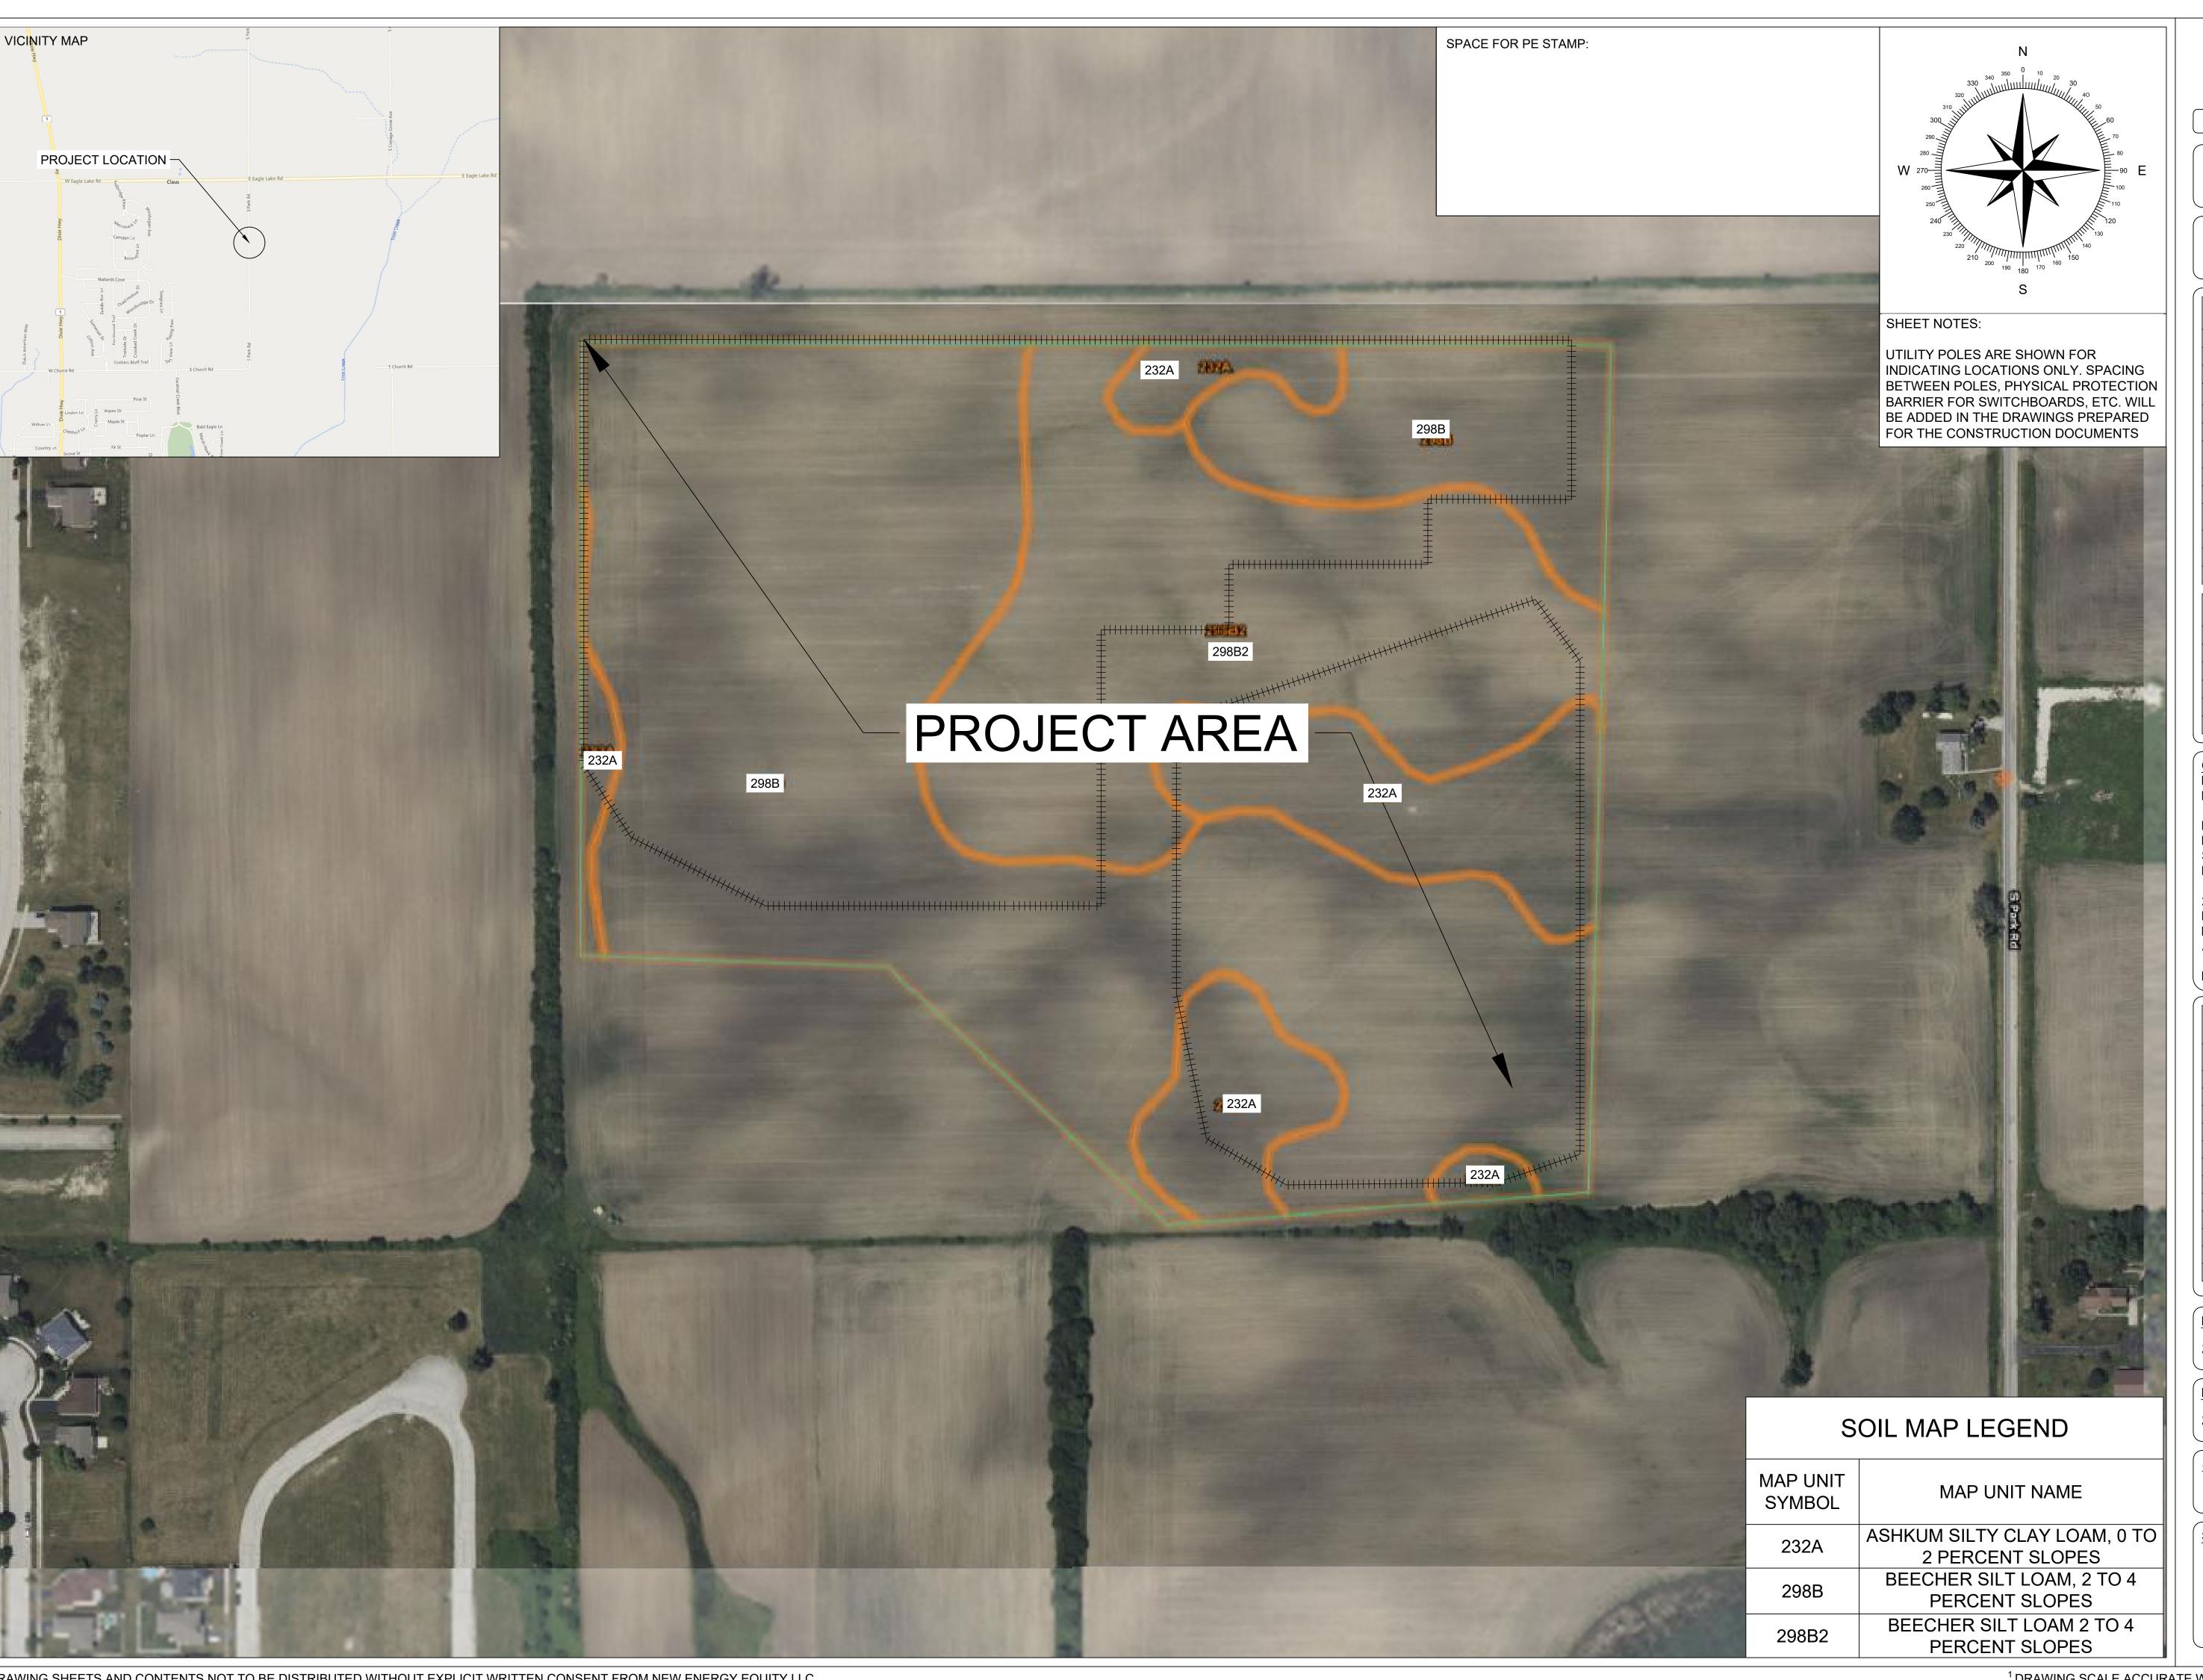



NEW ENERGY EQUITY, LLC 2530 RIVA ROAD, SUITE 200 ANNAPOLIS, MD 21041 NEWENERGYEQUITY.COM 443-267-5012

PROJECT ADDRESS 28964 S PARK AVE BEECHER, IL 60401

LAT: 41.365 LONG: -87.602

SPECIFICATIONS	SYSTEM
7.378 MW	SYSTEM SIZE DC
POWER LIMITED TO 5.000 MW	SYSTEM SIZE AC
1.476	DC/AC RATIO
180°	AZIMUTH
+/- 52°	TILT
12720	MODULE COUNT
HANWHA Q.PEAK DUO XL-G11.3/BFG	MODULE TYPE
580 W	MODULE STC RATING
34	INVERTER COUNT
SMA SUNNY HIGHPOWER PEAK-3 150kW	INVERTER TYPE
POWER LIMITED TO 147.058 kW	INVERTER POWER
TBD	RACKING
ALSO ENERGY	MONITORING

DESIGN CRITERIA		
MIN/MAX TEMP.	-22°C / 33°C	
WIND SPEED (ASCE 7-10)	105 MPH	
BUILDING CATEGORY	I	
EXPOSURE CATEGORY	С	
GROUND SNOW LOAD	25 PSF	
BUILDING HEIGHT	0'-0"	

OTHER NOTES E-911 ADDRESS TO BE APPLIED FOR WITH **BUILDING PERMIT**

NO POSITION, DISTANCE, OR CLEARANCE ISSUES WITH OVERHEAD ELECTRIC SERVICE LINES OR OTHER UTILITIES IN RELATION TO THE PV PANELS.

24/7 UNESCORTED KEYLESS ACCESS PROVIDED FOR ALL UTILITY ENERGY
EQUIPMENT INCLUDING THE METERS AND AC DISCONNECT.

INTERCONNECTION TYPE: PRIMARY


	REVISIONS		
#	DESCRIPTION	BY	DATE
0	ORIGINAL DESIGN	SP	3/20/2023
1	CUP PACKAGE	SP	3/22/2023
2	ACCESS RD CHANGE	SP	4/5/2023
3	1.55 DC/AC RATIO CHANGE	SP	12/7/2023
4	SLD WYE-DELTA WYE	SP	3/14/2024
5	CUP REFRESH	SP	4/30/2024
6	GAS LINE ADDITION	SP	5/9/2024
7	VISUAL SCREENING PAGES	SP	5/28/2024
8			
9			
10			
11			

PROJECT NAME SICILIANO

DRAWING TITLE

SOIL MAP

SCALE 1

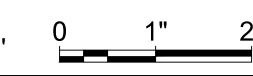

SHEET





NEW ENERGY EQUITY, LLC 2530 RIVA ROAD, SUITE 200 ANNAPOLIS, MD 21041 NEWENERGYEQUITY.COM 443-267-5012

PROJECT ADDRESS 28964 S PARK AVE BEECHER, IL 60401

LAT: 41.365 LONG: -87.602

SYSTEM SPECIFICATIONS		
SYSTEM SIZE DC	7.378 MW	
SYSTEM SIZE AC	POWER LIMITED TO 5.000 MW	
DC/AC RATIO	1.476	
AZIMUTH	180°	
TILT	+/- 52°	
MODULE COUNT	12720	
MODULE TYPE	HANWHA Q.PEAK DUO XL-G11.3/BFG	
MODULE STC RATING	580 W	
INVERTER COUNT	34	
INVERTER TYPE	SMA SUNNY HIGHPOWER PEAK-3 150kW	
INVERTER POWER	POWER LIMITED TO 147.058 kW	
RACKING	TBD	
MONITORING	ALSO ENERGY	

DESIGN CRITERIA		
MIN/MAX TEMP.	-22°C / 33°C	
WIND SPEED (ASCE 7-10)	105 MPH	
BUILDING CATEGORY	1	
EXPOSURE CATEGORY	С	
GROUND SNOW LOAD	25 PSF	
BUILDING HEIGHT	0'-0"	

OTHER NOTES E-911 ADDRESS TO BE APPLIED FOR WITH BUILDING PERMIT

NO POSITION, DISTANCE, OR CLEARANCE ISSUES WITH OVERHEAD ELECTRIC SERVICE LINES OR OTHER UTILITIES IN RELATION TO THE PV PANELS.

24/7 UNESCORTED KEYLESS ACCESS PROVIDED FOR ALL UTILITY ENERGY
EQUIPMENT INCLUDING THE METERS AND
AC DISCONNECT.

INTERCONNECTION TYPE: PRIMARY

	REVISIONS		
#	DESCRIPTION	BY	DATE
0	ORIGINAL DESIGN	SP	3/20/2023
1	CUP PACKAGE	SP	3/22/2023
2	ACCESS RD CHANGE	SP	4/5/2023
3	1.55 DC/AC RATIO CHANGE	SP	12/7/2023
4	SLD WYE-DELTA WYE	SP	3/14/2024
5	CUP REFRESH	SP	4/30/2024
6	GAS LINE ADDITION	SP	5/9/2024
7	VISUAL SCREENING PAGES	SP	5/28/2024
8			
9			
10			
11			

PROJECT NAME

SICILIANO

DRAWING TITLE

TOPOGRAPHY & DRAINAGE





NEW ENERGY EQUITY, LLC 2530 RIVA ROAD, SUITE 200 ANNAPOLIS, MD 21041 NEWENERGYEQUITY.COM 443-267-5012

PROJECT ADDRESS 28964 S PARK AVE BEECHER, IL 60401

LAT: 41.365 LONG: -87.602

SYSTEM SPECIFICATIONS		
SYSTEM SIZE DC	7.378 MW	
SYSTEM SIZE AC	POWER LIMITED TO 5.000 MW	
DC/AC RATIO	1.476	
AZIMUTH	180°	
TILT	+/- 52°	
MODULE COUNT	12720	
MODULE TYPE	HANWHA Q.PEAK DUO XL-G11.3/BFG	
MODULE STC RATING	580 W	
INVERTER COUNT	34	
INVERTER TYPE	SMA SUNNY HIGHPOWER PEAK-3 150kW	
INVERTER POWER	POWER LIMITED TO 147.058 kW	
RACKING	TBD	
MONITORING	ALSO ENERGY	

DESIGN CRITERIA			
MIN/MAX TEMP22°C / 33°C			
WIND SPEED (ASCE 7-10)	105 MPH		
BUILDING CATEGORY	I		
EXPOSURE CATEGORY	С		
GROUND SNOW LOAD	25 PSF		
BUILDING HEIGHT	0'-0"		

OTHER NOTES E-911 ADDRESS TO BE APPLIED FOR WITH BUILDING PERMIT

NO POSITION, DISTANCE, OR CLEARANCE ISSUES WITH OVERHEAD ELECTRIC SERVICE LINES OR OTHER UTILITIES IN RELATION TO THE PV PANELS.

24/7 UNESCORTED KEYLESS ACCESS PROVIDED FOR ALL UTILITY ENERGY EQUIPMENT INCLUDING THE METERS AND AC DISCONNECT.

INTERCONNECTION TYPE: PRIMARY

	REVISIONS		
#	DESCRIPTION	BY	DATE
0	ORIGINAL DESIGN	SP	3/20/2023
1	CUP PACKAGE	SP	3/22/2023
2	ACCESS RD CHANGE	SP	4/5/2023
3	1.55 DC/AC RATIO CHANGE	SP	12/7/2023
4	SLD WYE-DELTA WYE	SP	3/14/2024
5	CUP REFRESH	SP	4/30/2024
6	GAS LINE ADDITION	SP	5/9/2024
7	VISUAL SCREENING PAGES	SP	5/28/2024
8			
9			
10			
11			

PROJECT NAME


SICILIANO


DRAWING TITLE

CONSTURCTION & MAINTENANCE ROUTES


SCALE 1

SHEET

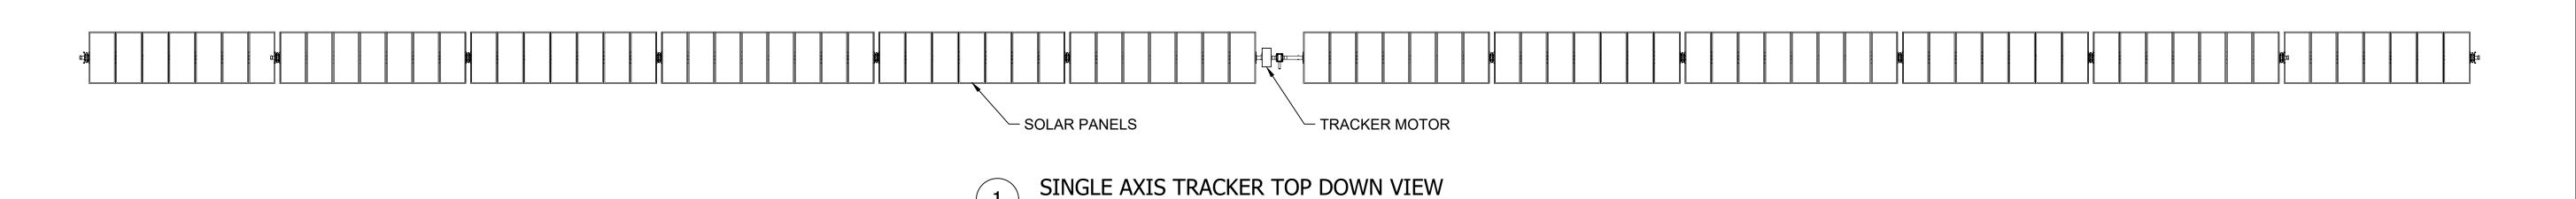

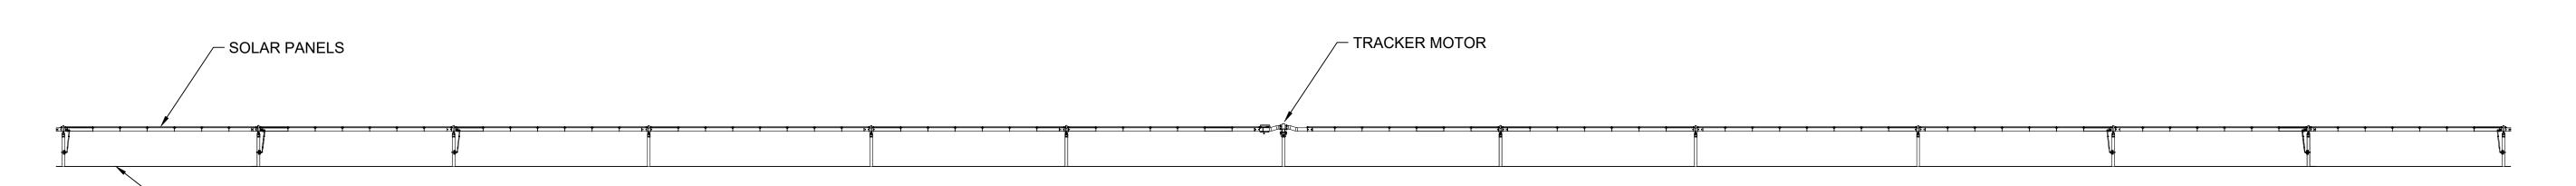

2 SINGLE AXIS TRACKER EAST-WEST ELEVATION NTS

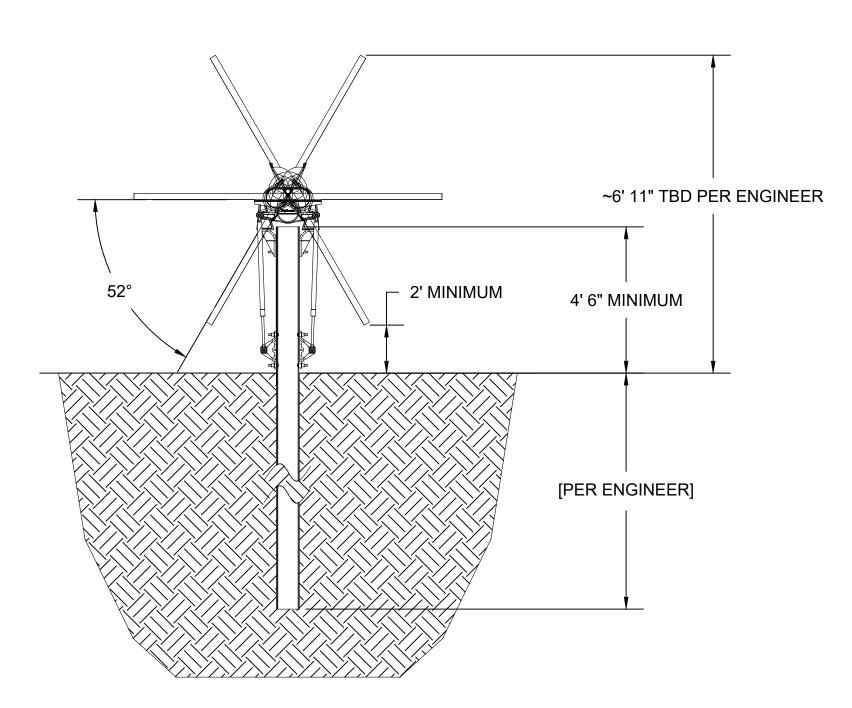

3 SINGLE AXIS TRACKER NORTH-SOUTH ELEVATION NTS



PROJECT ENTITY: WILD CAT SOLAR 4 LLC - SICILIANO

NEW ENERGY EQUITY, LLC 2530 RIVA ROAD, SUITE 200 ANNAPOLIS, MD 21041 NEWENERGYEQUITY.COM 443-267-5012

PROJECT ADDRESS 28964 S PARK AVE BEECHER, IL 60401

LAT: 41.365 LONG: -87.602

SYSTEM	SPECIFICATIONS
SYSTEM SIZE DC	7.378 MW
SYSTEM SIZE AC	POWER LIMITED TO 5.000 MW
DC/AC RATIO	1.476
AZIMUTH	180°
TILT	+/- 52°
MODULE COUNT	12720
MODULE TYPE	HANWHA Q.PEAK DUO XL-G11.3/BFG
MODULE STC RATING	580 W
INVERTER COUNT	34
INVERTER TYPE	SMA SUNNY HIGHPOWER PEAK-3 150kW
INVERTER POWER	POWER LIMITED TO 147.058 kW
RACKING	TBD
MONITORING	ALSO ENERGY

DESIGN CRITERIA		
-22°C / 33°C		
105 MPH		
I		
С		
25 PSF		
0'-0"		

OTHER NOTES
E-911 ADDRESS TO BE APPLIED FOR WITH
BUILDING PERMIT

NO POSITION, DISTANCE, OR CLEARANCE ISSUES WITH OVERHEAD ELECTRIC SERVICE LINES OR OTHER UTILITIES IN RELATION TO THE PV PANELS.

24/7 UNESCORTED KEYLESS ACCESS
PROVIDED FOR ALL UTILITY ENERGY
EQUIPMENT INCLUDING THE METERS AND
AC DISCONNECT.

INTERCONNECTION TYPE: PRIMARY

REVISIONS			
#	DESCRIPTION	BY	DATE
0	ORIGINAL DESIGN	SP	3/20/202
1	CUP PACKAGE	SP	3/22/202
2	ACCESS RD CHANGE	SP	4/5/202
3	1.55 DC/AC RATIO CHANGE	SP	12/7/202
4	SLD WYE-DELTA WYE	SP	3/14/202
5	CUP REFRESH	SP	4/30/202
6	GAS LINE ADDITION	SP	5/9/202
7	VISUAL SCREENING PAGES	SP	5/28/202
8			
9			
10			
11			

PROJECT NAME

SICILIANO

DRAWING TITLE


SAT RACKING DETAIL

SCALE 1


NTS

SHEET

PV7

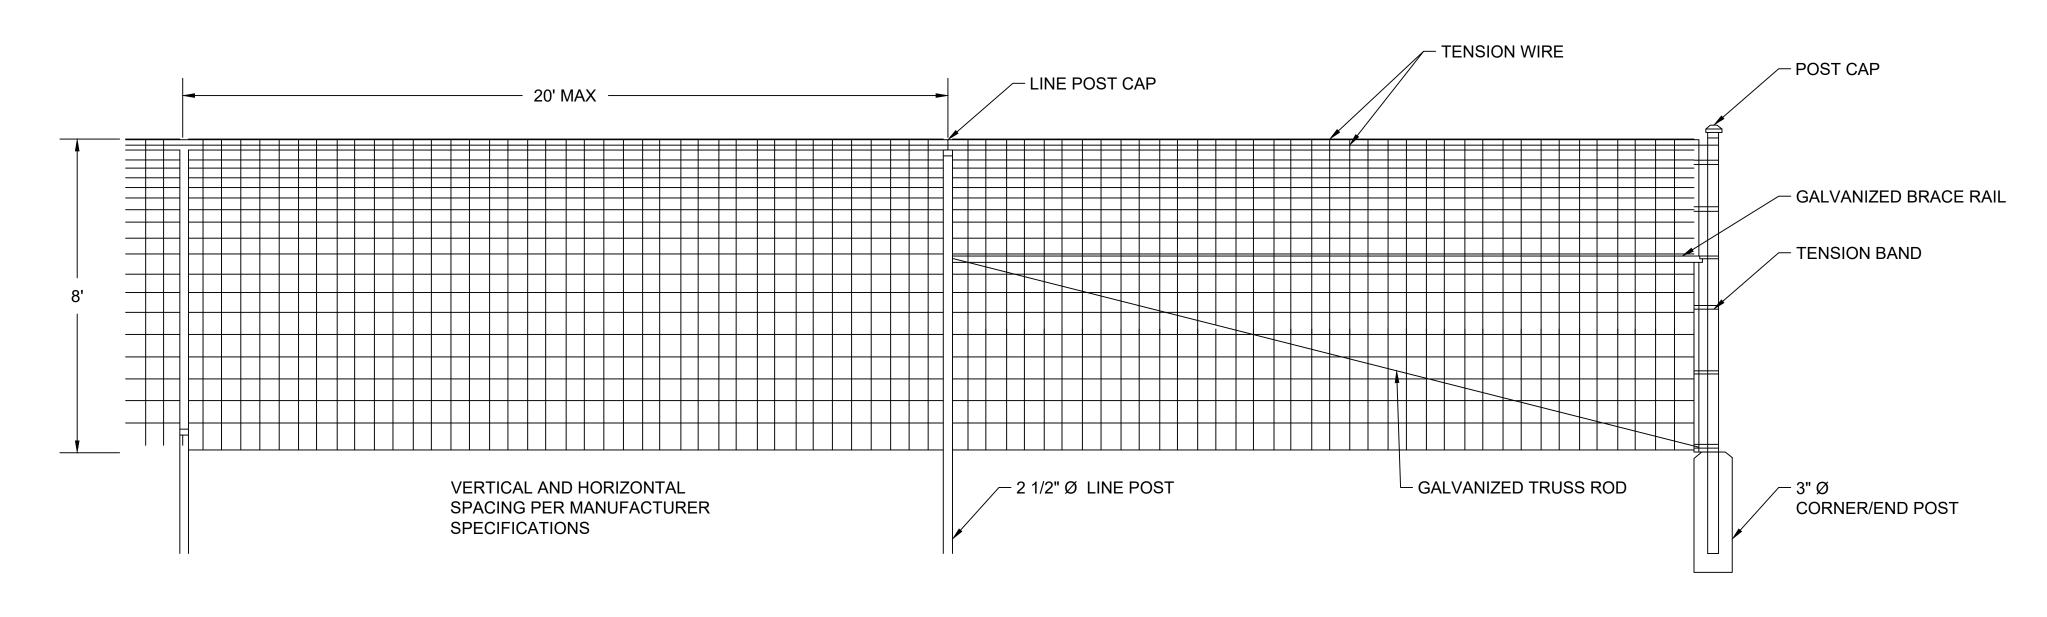

8' FIXED KNOT FENCE NTS

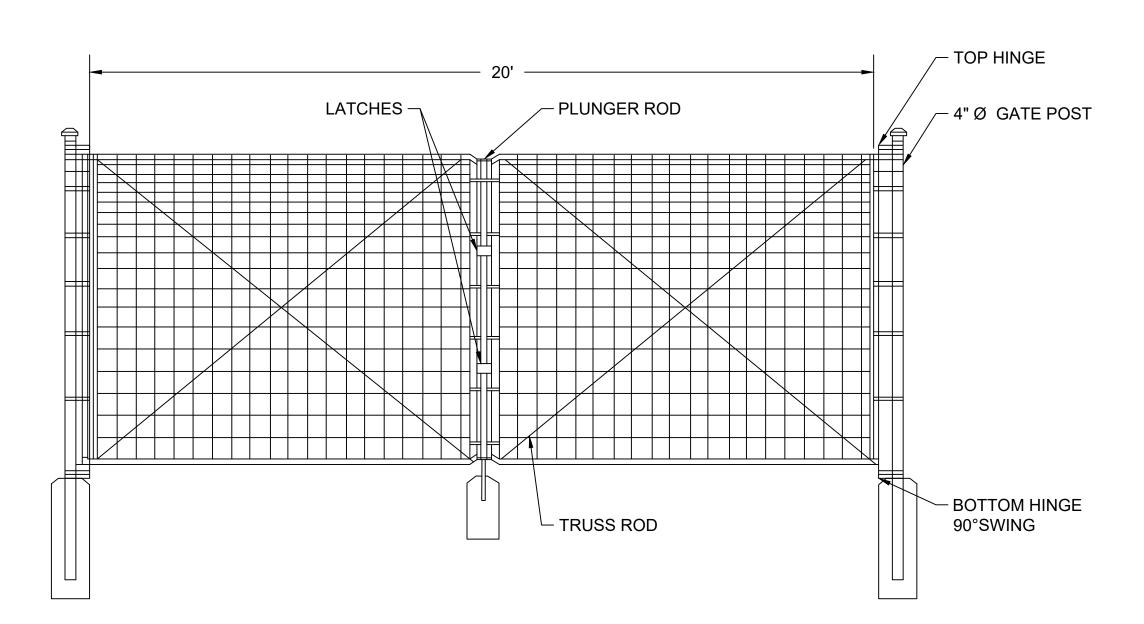

8' FIXED KNOT FENCE GATE

- 1. THIS DRAWING IS FOR INFORMATIONAL PURPOSES ONLY
- AND NOT TO BE USED FOR CONTRUCTION.
- 2. DO NOT SCALE DRAWING



PROJECT ENTITY: WILD CAT SOLAR 4 LLC - SICILIANO

NEW ENERGY EQUITY, LLC 2530 RIVA ROAD, SUITE 200 ANNAPOLIS, MD 21041 NEWENERGYEQUITY.COM 443-267-5012

28964 S PARK AVE BEECHER, IL 60401

LAT: 41.365 LONG: -87.602

SYSTEM	SPECIFICATIONS
SYSTEM SIZE DC	7.378 MW
SYSTEM SIZE AC	POWER LIMITED TO 5.000 MW
DC/AC RATIO	1.476
AZIMUTH	180°
TILT	+/- 52°
MODULE COUNT	12720
MODULE TYPE	HANWHA Q.PEAK DUO XL-G11.3/BFG
MODULE STC RATING	580 W
INVERTER COUNT	34
INVERTER TYPE	SMA SUNNY HIGHPOWER PEAK-: 150kW
INVERTER POWER	POWER LIMITED TO 147.058 kW
RACKING	TBD
MONITORING	ALSO ENERGY

DESIGN CRITERIA		
MIN/MAX TEMP.	-22°C / 33°C	
WIND SPEED (ASCE 7-10)	105 MPH	
BUILDING CATEGORY	Ţ	
EXPOSURE CATEGORY	С	
GROUND SNOW LOAD	25 PSF	
BUILDING HEIGHT	0'-0"	

OTHER NOTES E-911 ADDRESS TO BE APPLIED FOR WITH BUILDING PERMIT

NO POSITION, DISTANCE, OR CLEARANCE ISSUES WITH OVERHEAD ELECTRIC SERVICE LINES OR OTHER UTILITIES IN RELATION TO THE PV PANELS.

24/7 UNESCORTED KEYLESS ACCESS PROVIDED FOR ALL UTILITY ENERGY EQUIPMENT INCLUDING THE METERS AND AC DISCONNECT.

INTERCONNECTION TYPE: PRIMARY

	REVISIONS		
#	DESCRIPTION	BY	DATE
0	ORIGINAL DESIGN	SP	3/20/2023
1	CUP PACKAGE	SP	3/22/2023
2	ACCESS RD CHANGE	SP	4/5/2023
3	1.55 DC/AC RATIO CHANGE	SP	12/7/2023
4	SLD WYE-DELTA WYE	SP	3/14/2024
5	CUP REFRESH	SP	4/30/2024
6	GAS LINE ADDITION	SP	5/9/2024
7	VISUAL SCREENING PAGES	SP	5/28/2024
8			
9			
10			
11			


PROJECT NAME SICILIANO


DRAWING TITLE


FENCE DETAIL

SCALE 1


NTS

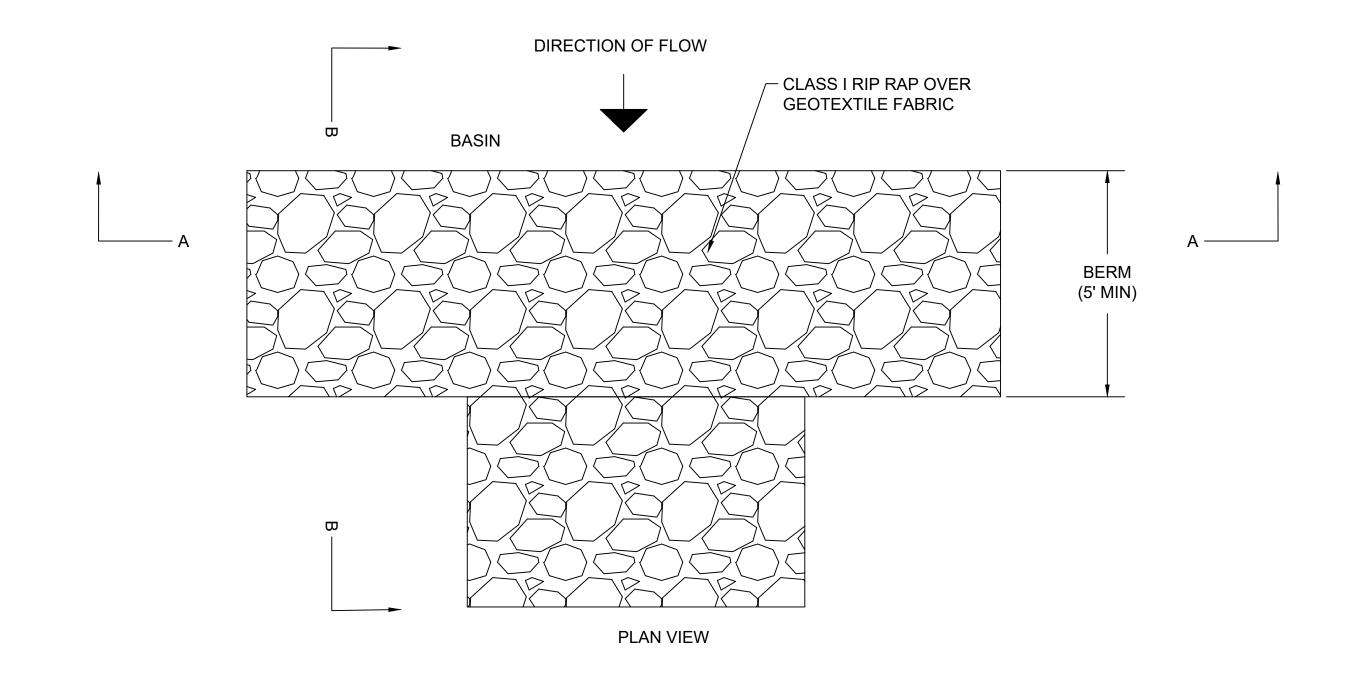

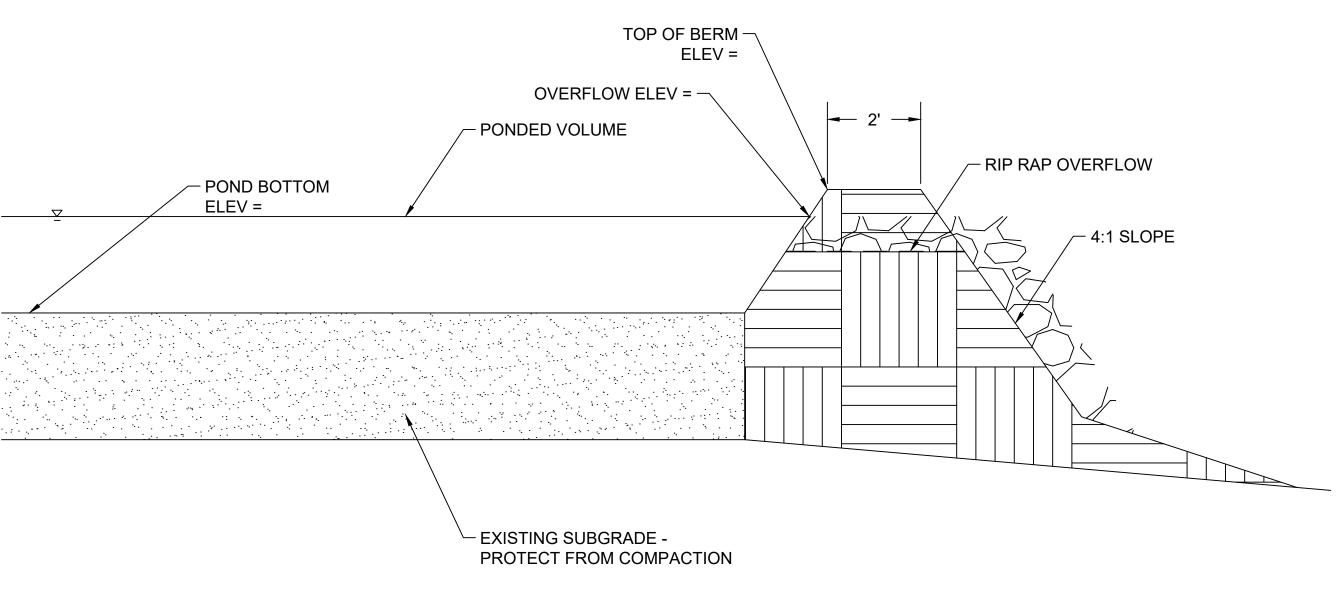

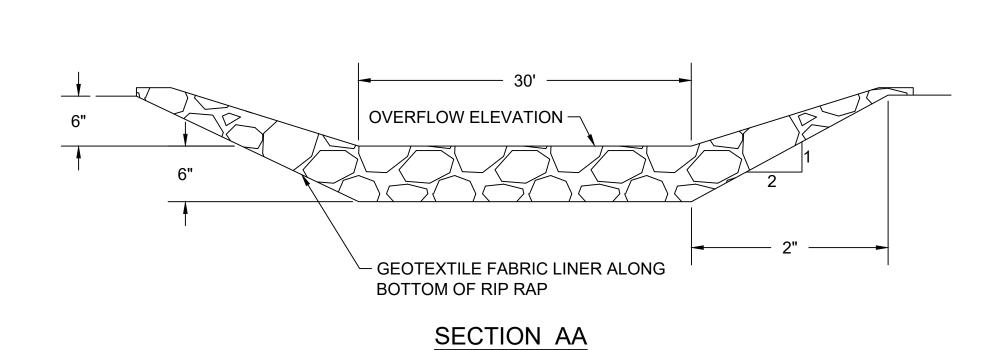



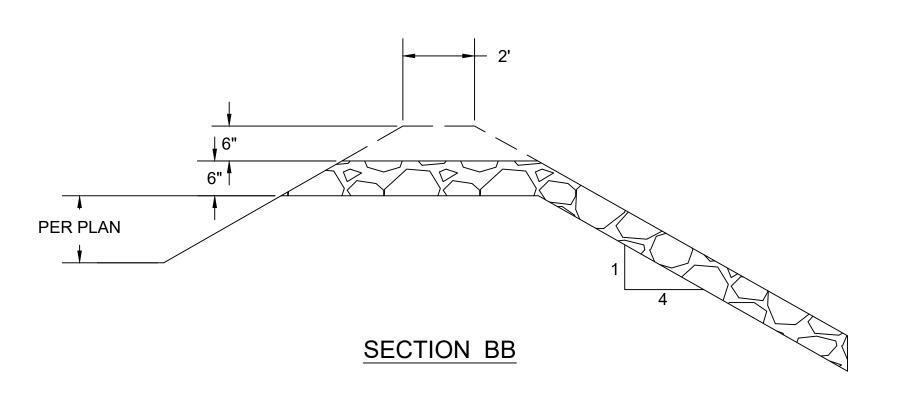

2 RIP RAP OVERFLOW NTS



PROJECT ENTITY: WILD CAT SOLAR 4 LLC - SICILIANO

NEW ENERGY EQUITY, LLC 2530 RIVA ROAD, SUITE 200 ANNAPOLIS, MD 21041 NEWENERGYEQUITY.COM 443-267-5012

PROJECT ADDRESS 28964 S PARK AVE BEECHER, IL 60401

LAT: 41.365 LONG: -87.602

SYSTEM	SPECIFICATIONS
SYSTEM SIZE DC	7.378 MW
SYSTEM SIZE AC	POWER LIMITED TO 5.000 MW
DC/AC RATIO	1.476
AZIMUTH	180°
TILT	+/- 52°
MODULE COUNT	12720
MODULE TYPE	HANWHA Q.PEAK DUO XL-G11.3/BFG
MODULE STC RATING	580 W
INVERTER COUNT	34
INVERTER TYPE	SMA SUNNY HIGHPOWER PEAK-3 150kW
INVERTER POWER	POWER LIMITED TO 147.058 kW
RACKING	TBD
MONITORING	ALSO ENERGY

DESIGN CRITERIA				
MIN/MAX TEMP.	-22°C / 33°C			
WIND SPEED (ASCE 7-10)	105 MPH			
BUILDING CATEGORY	I			
EXPOSURE CATEGORY	С			
GROUND SNOW LOAD	25 PSF			
BUILDING HEIGHT	0'-0"			

OTHER NOTES
E-911 ADDRESS TO BE APPLIED FOR WITH
BUILDING PERMIT

NO POSITION, DISTANCE, OR CLEARANCE ISSUES WITH OVERHEAD ELECTRIC SERVICE LINES OR OTHER UTILITIES IN RELATION TO THE PV PANELS.

24/7 UNESCORTED KEYLESS ACCESS
PROVIDED FOR ALL UTILITY ENERGY
EQUIPMENT INCLUDING THE METERS AND
AC DISCONNECT.

INTERCONNECTION TYPE: PRIMARY

REVISIONS			
#	DESCRIPTION	BY	DATE
0	ORIGINAL DESIGN	SP	3/20/202
1	CUP PACKAGE	SP	3/22/202
2	ACCESS RD CHANGE	SP	4/5/202
3	1.55 DC/AC RATIO CHANGE	SP	12/7/202
4	SLD WYE-DELTA WYE	SP	3/14/202
5	CUP REFRESH	SP	4/30/202
6	GAS LINE ADDITION	SP	5/9/202
7	VISUAL SCREENING PAGES	SP	5/28/202
8			
9			
10			
11			

PROJECT NAME

SICILIANO

DRAWING TITLE

STORMWATER BASIN DETAIL

SCALE 1

NTS

SHEET

PV9




PLANTING SCHEDULE

TYPE: BLACK HILLS SPRUCE


HEIGHT: 6' MIN WITHIN 3 YEARS OF PLANTING


NUMBER OF ROWS: 2 SPACING: 16' O.C.

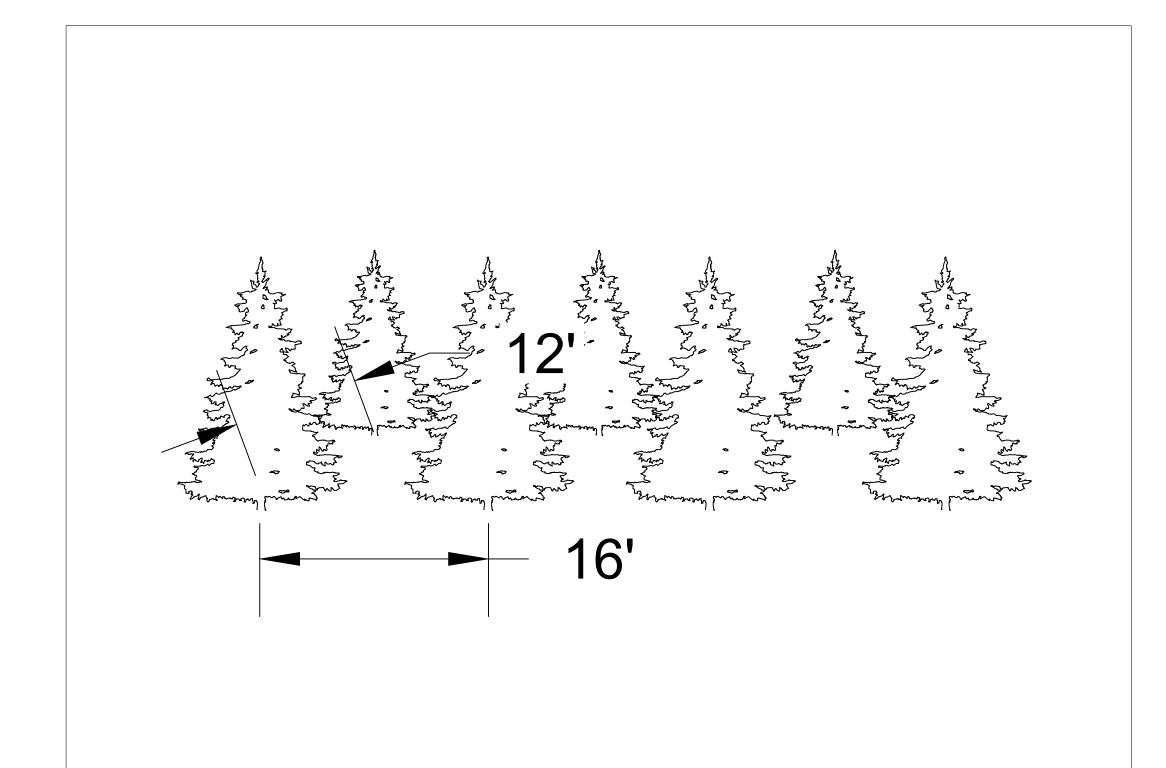

BLACK HILLS SPRUCE SCREENING

Scale: N.T.S.

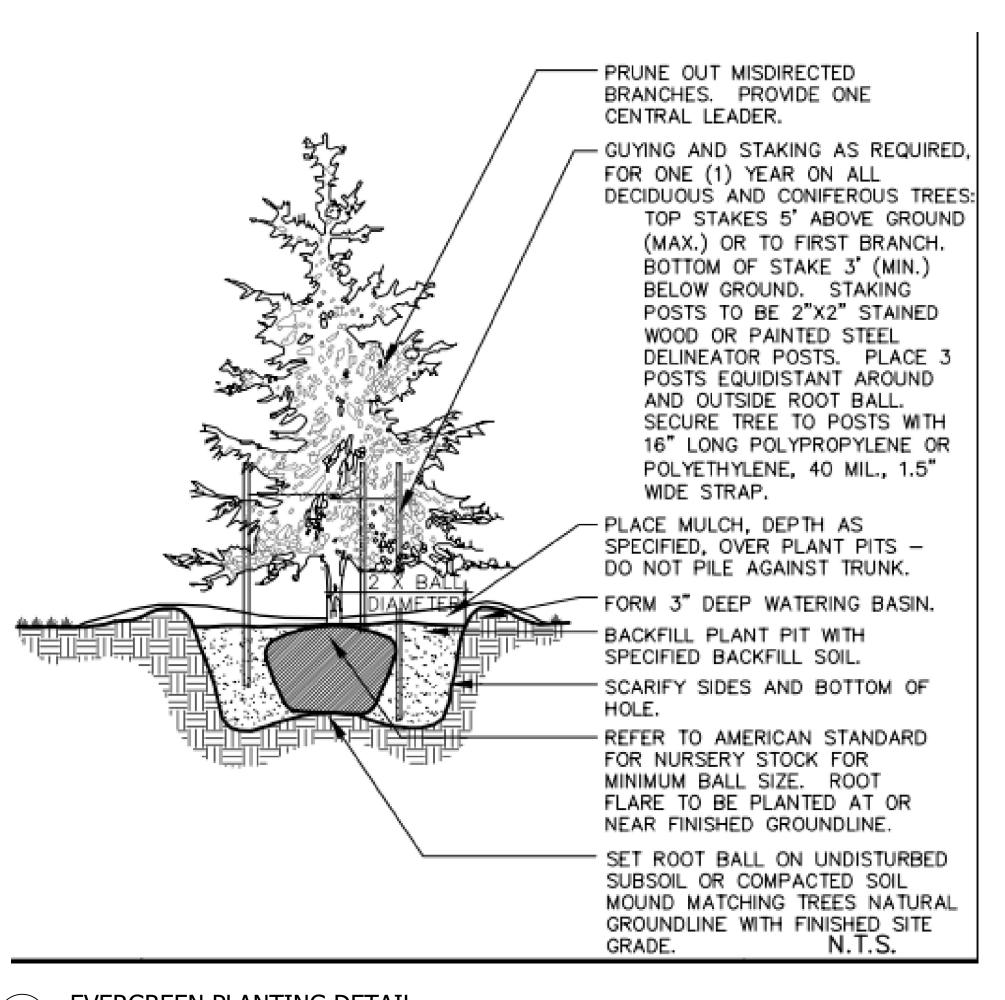

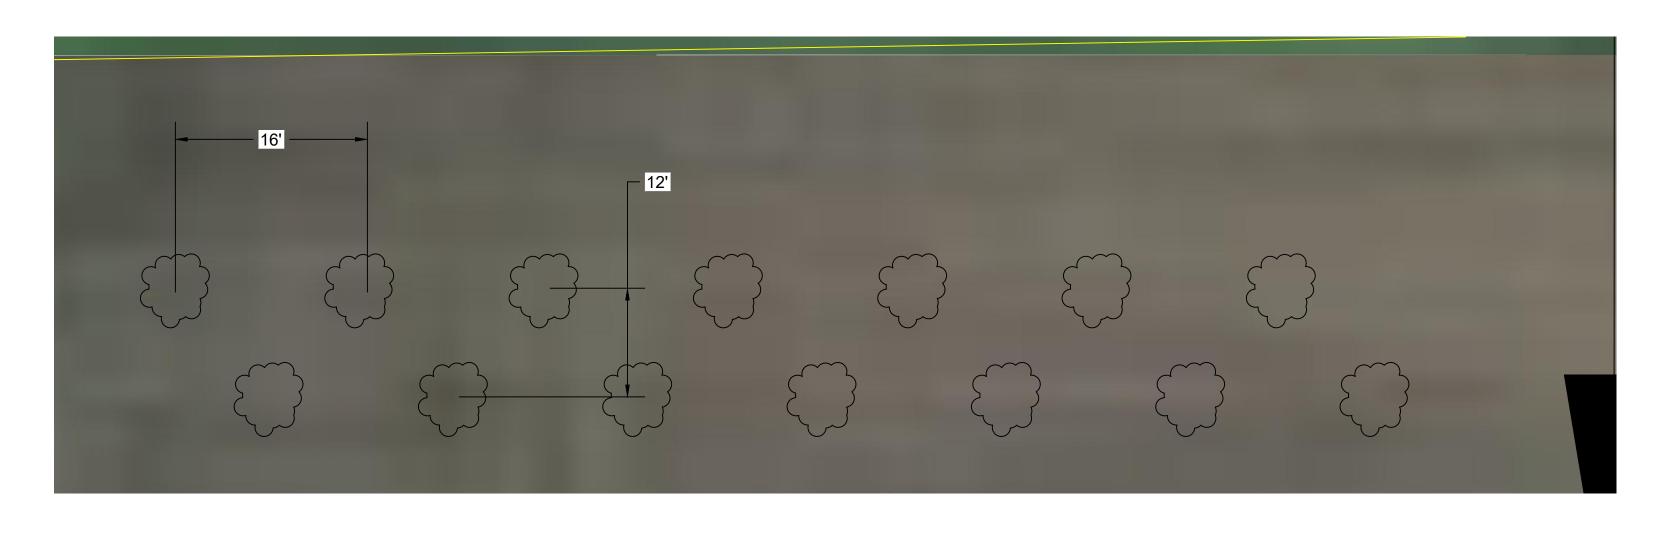

1" = 8'

3 PLAN VIEW

EVERGREEN PLANTING DETAIL

Scale: N.T.S.



PROJECT ENTITY: WILD CAT SOLAR 4 LLC - SICILIANO

NEW ENERGY EQUITY, LLC 2530 RIVA ROAD, SUITE 200 ANNAPOLIS, MD 21041 NEWENERGYEQUITY.COM 443-267-5012

PROJECT ADDRESS 28964 S PARK AVE BEECHER, IL 60401

LAT: 41.365 LONG: -87.602

SYSTEM	SPECIFICATIONS
SYSTEM SIZE DC	7.378 MW
SYSTEM SIZE AC	POWER LIMITED TO 5.000 MW
DC/AC RATIO	1.476
AZIMUTH	180°
TILT	+/- 52°
MODULE COUNT	12720
MODULE TYPE	HANWHA Q.PEAK DUO XL-G11.3/BFG
MODULE STC RATING	580 W
INVERTER COUNT	34
INVERTER TYPE	SMA SUNNY HIGHPOWER PEAK 150kW
INVERTER POWER	POWER LIMITED TO 147.058 kV
RACKING	TBD
MONITORING	ALSO ENERGY

DESIGN CRITERIA		
MIN/MAX TEMP.	-22°C / 33°C	
WIND SPEED (ASCE 7-10)	105 MPH	
BUILDING CATEGORY	I	
EXPOSURE CATEGORY	С	
GROUND SNOW LOAD	25 PSF	
BUILDING HEIGHT	0'-0"	
	MIN/MAX TEMP. WIND SPEED (ASCE 7-10) BUILDING CATEGORY EXPOSURE CATEGORY GROUND SNOW LOAD	

OTHER NOTES
E-911 ADDRESS TO BE APPLIED FOR WITH
BUILDING PERMIT

NO POSITION, DISTANCE, OR CLEARANCE ISSUES WITH OVERHEAD ELECTRIC SERVICE LINES OR OTHER UTILITIES IN RELATION TO THE PV PANELS.

24/7 UNESCORTED KEYLESS ACCESS PROVIDED FOR ALL UTILITY ENERGY EQUIPMENT INCLUDING THE METERS AND AC DISCONNECT.

INTERCONNECTION TYPE: PRIMARY

	REVISIONS		
#	DESCRIPTION	BY	DATE
0	ORIGINAL DESIGN	SP	3/20/2023
1	CUP PACKAGE	SP	3/22/2023
2	ACCESS RD CHANGE	SP	4/5/2023
3	1.55 DC/AC RATIO CHANGE	SP	12/7/2023
4	SLD WYE-DELTA WYE	SP	3/14/2024
5	CUP REFRESH	SP	4/30/2024
6	GAS LINE ADDITION	SP	5/9/2024
7	VISUAL SCREENING PAGES	SP	5/28/2024
8			
9			
10			
11			

PROJECT NAME
SICILIANO

DRAWING TITLE


SCREENING PLAN

SCALE 1

NTS

SHEET

PV10

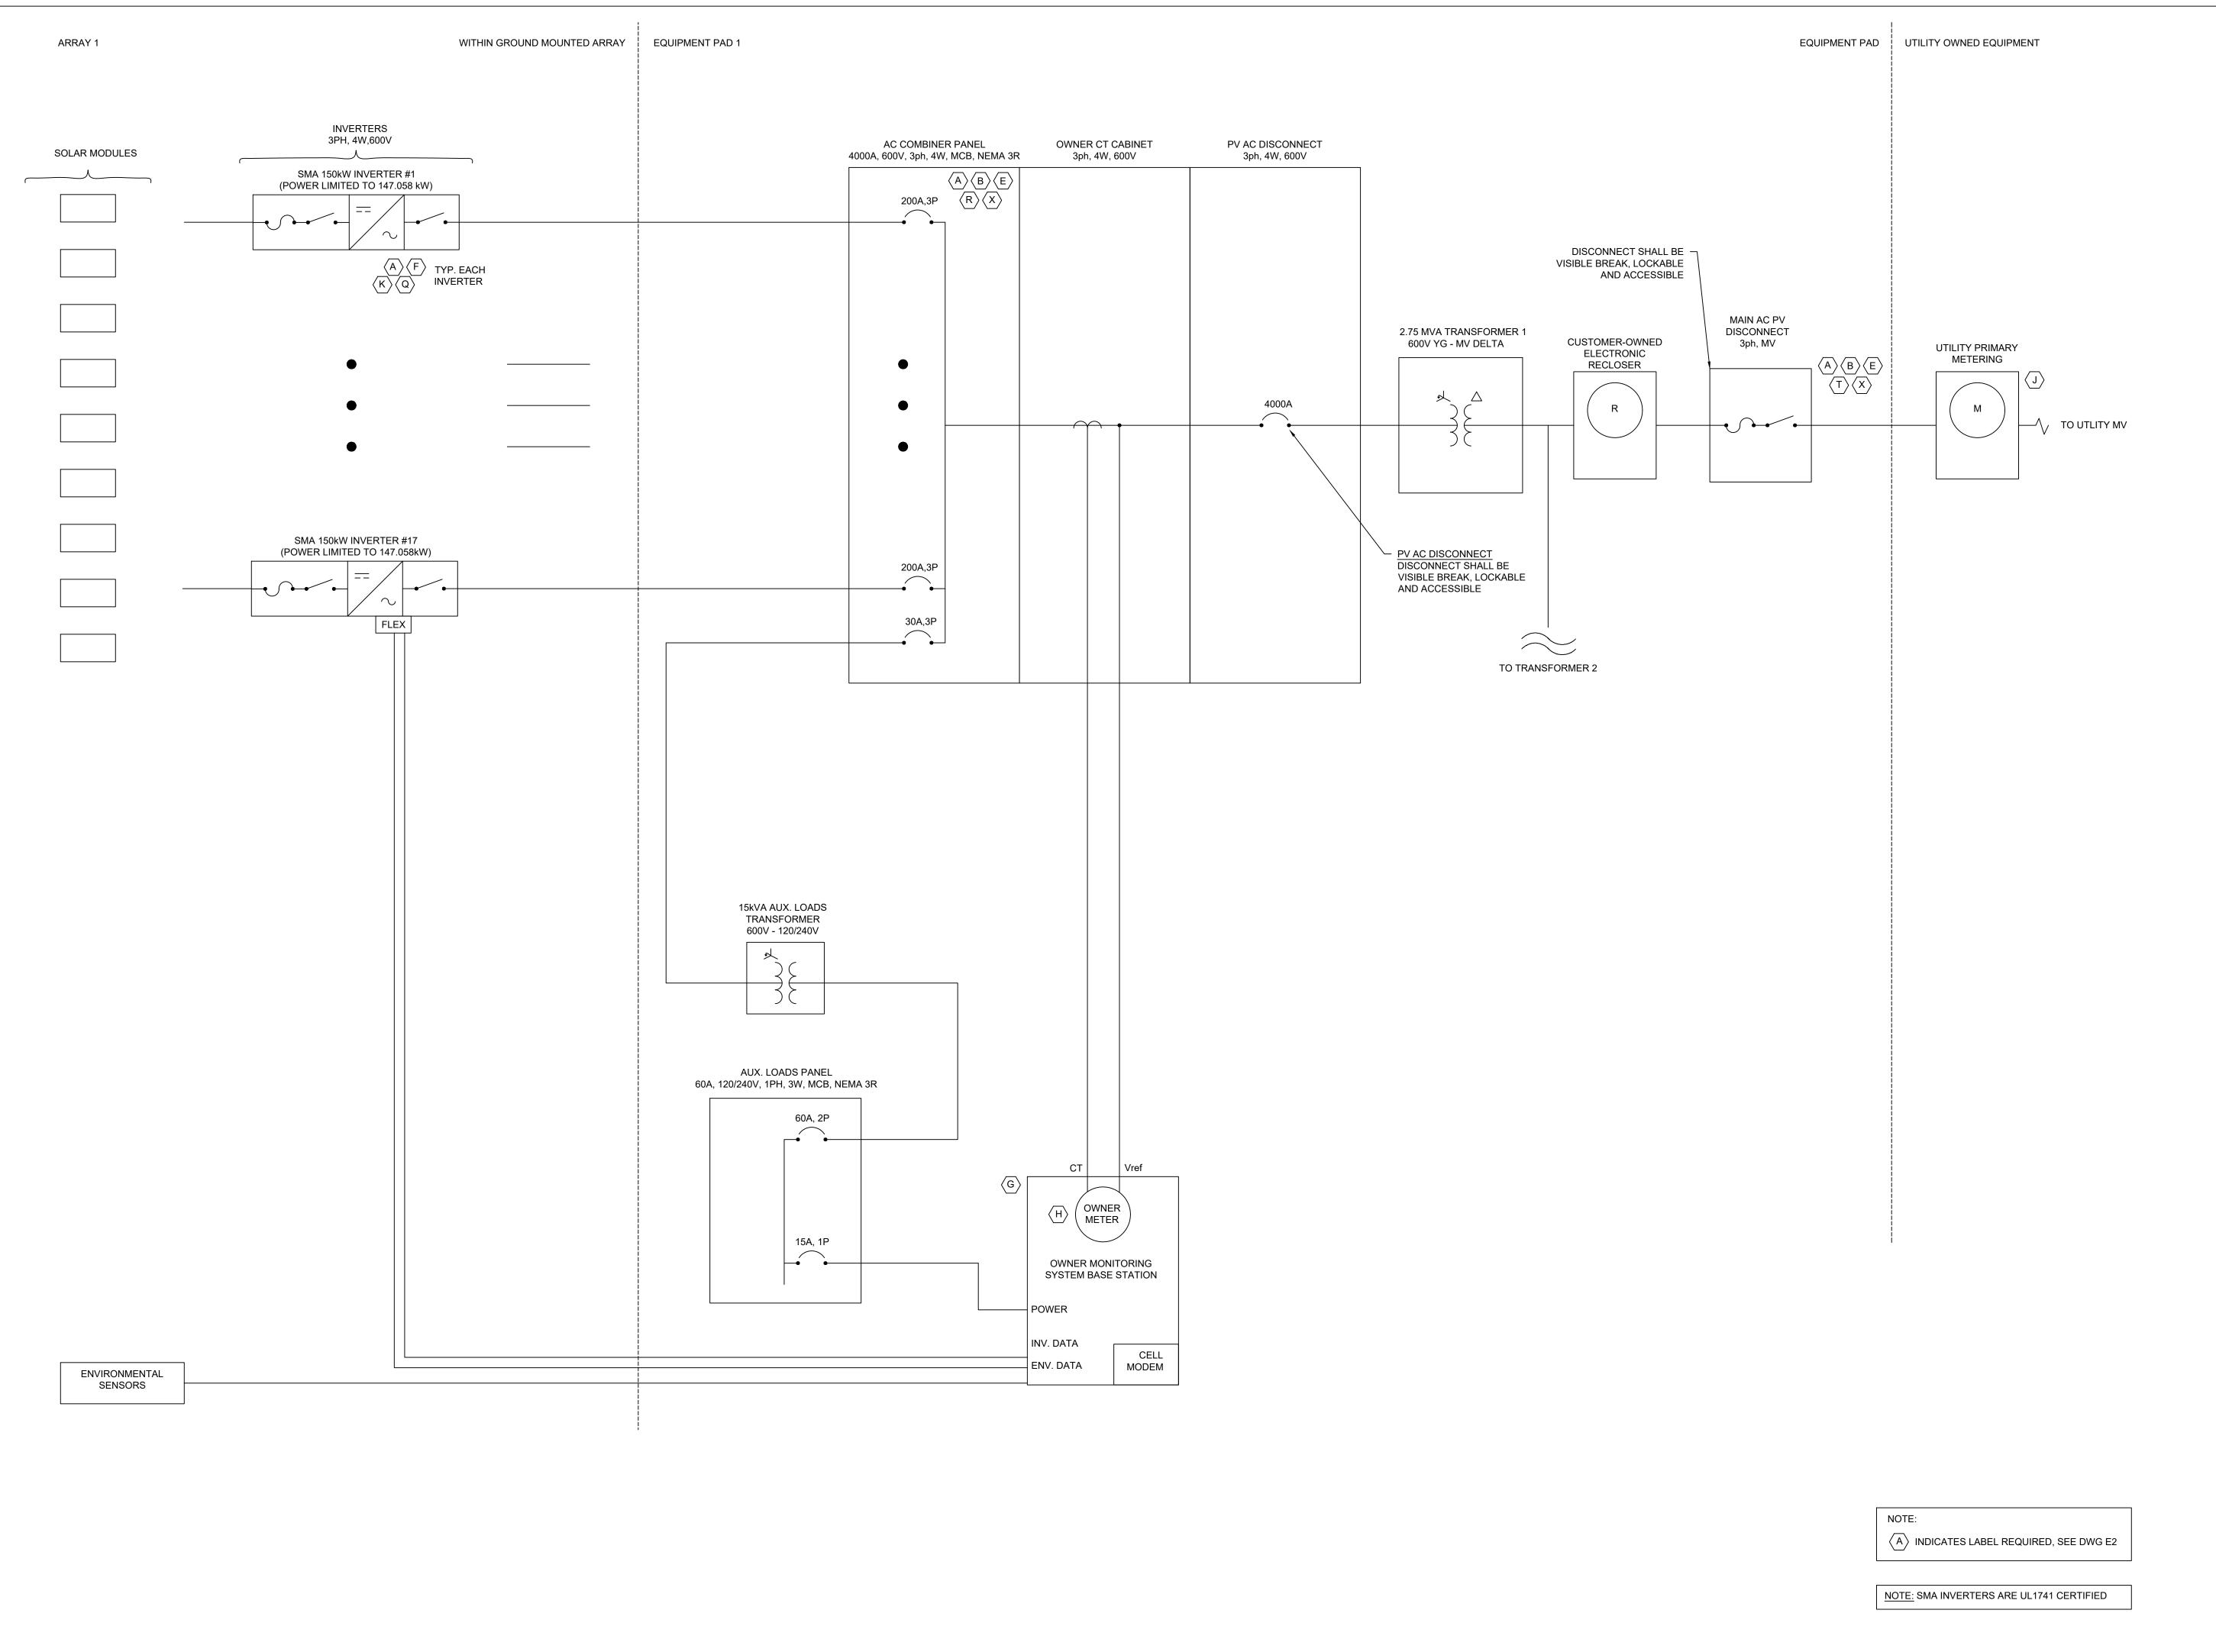



NEW ENERGY EQUITY, LLC 2530 RIVA ROAD, SUITE 200 ANNAPOLIS, MD 21041 NEWENERGYEQUITY.COM 443-267-5012

PROJECT ADDRESS 28964 S PARK AVE BEECHER, IL 60401

LAT: 41.365 LONG: -87.602

SYSTEM SPECIFICATIONS		
SYSTEM SIZE DC 7.378 MW		
SYSTEM SIZE AC	POWER LIMITED TO 5.000 MW	
DC/AC RATIO	1.476	
AZIMUTH	180°	
TILT	+/- 52°	
MODULE COUNT	12720	
MODULE TYPE	HANWHA Q.PEAK DUO XL-G11.3/BFG	
MODULE STC RATING	580 W	
INVERTER COUNT	34	
INVERTER TYPE	SMA SUNNY HIGHPOWER PEAK- 150kW	
INVERTER POWER	POWER LIMITED TO 147.058 kW	
RACKING	TBD	
MONITORING	ALSO ENERGY	

DESIGN CRITERIA		
MIN/MAX TEMP.	-22°C / 33°C	
WIND SPEED (ASCE 7-10)	105 MPH	
BUILDING CATEGORY	I	
EXPOSURE CATEGORY	С	
GROUND SNOW LOAD	25 PSF	
BUILDING HEIGHT	0'-0"	

OTHER NOTES
E-911 ADDRESS TO BE APPLIED FOR WITH
BUILDING PERMIT

NO POSITION, DISTANCE, OR CLEARANCE ISSUES WITH OVERHEAD ELECTRIC SERVICE LINES OR OTHER UTILITIES IN RELATION TO THE PV PANELS.

24/7 UNESCORTED KEYLESS ACCESS
PROVIDED FOR ALL UTILITY ENERGY
EQUIPMENT INCLUDING THE METERS AND
AC DISCONNECT.

INTERCONNECTION TYPE: PRIMARY

	REVISIONS		
# DESCRIPTION		BY	DATE
0	ORIGINAL DESIGN	SP	3/20/202
1	CUP PACKAGE	SP	3/22/202
2	ACCESS RD CHANGE	SP	4/5/202
3	1.55 DC/AC RATIO CHANGE	SP	12/7/202
4	SLD WYE-DELTA WYE	SP	3/14/202
5	CUP REFRESH	SP	4/30/202
6	GAS LINE ADDITION	SP	5/9/2024
7	VISUAL SCREENING PAGES	SP	5/28/202
8			
9			
10			
11			

PROJECT NAME

SICILIANO

DRAWING TITLE


SINGLE LINE

SCALE 1

NTS

SHEET

E1A

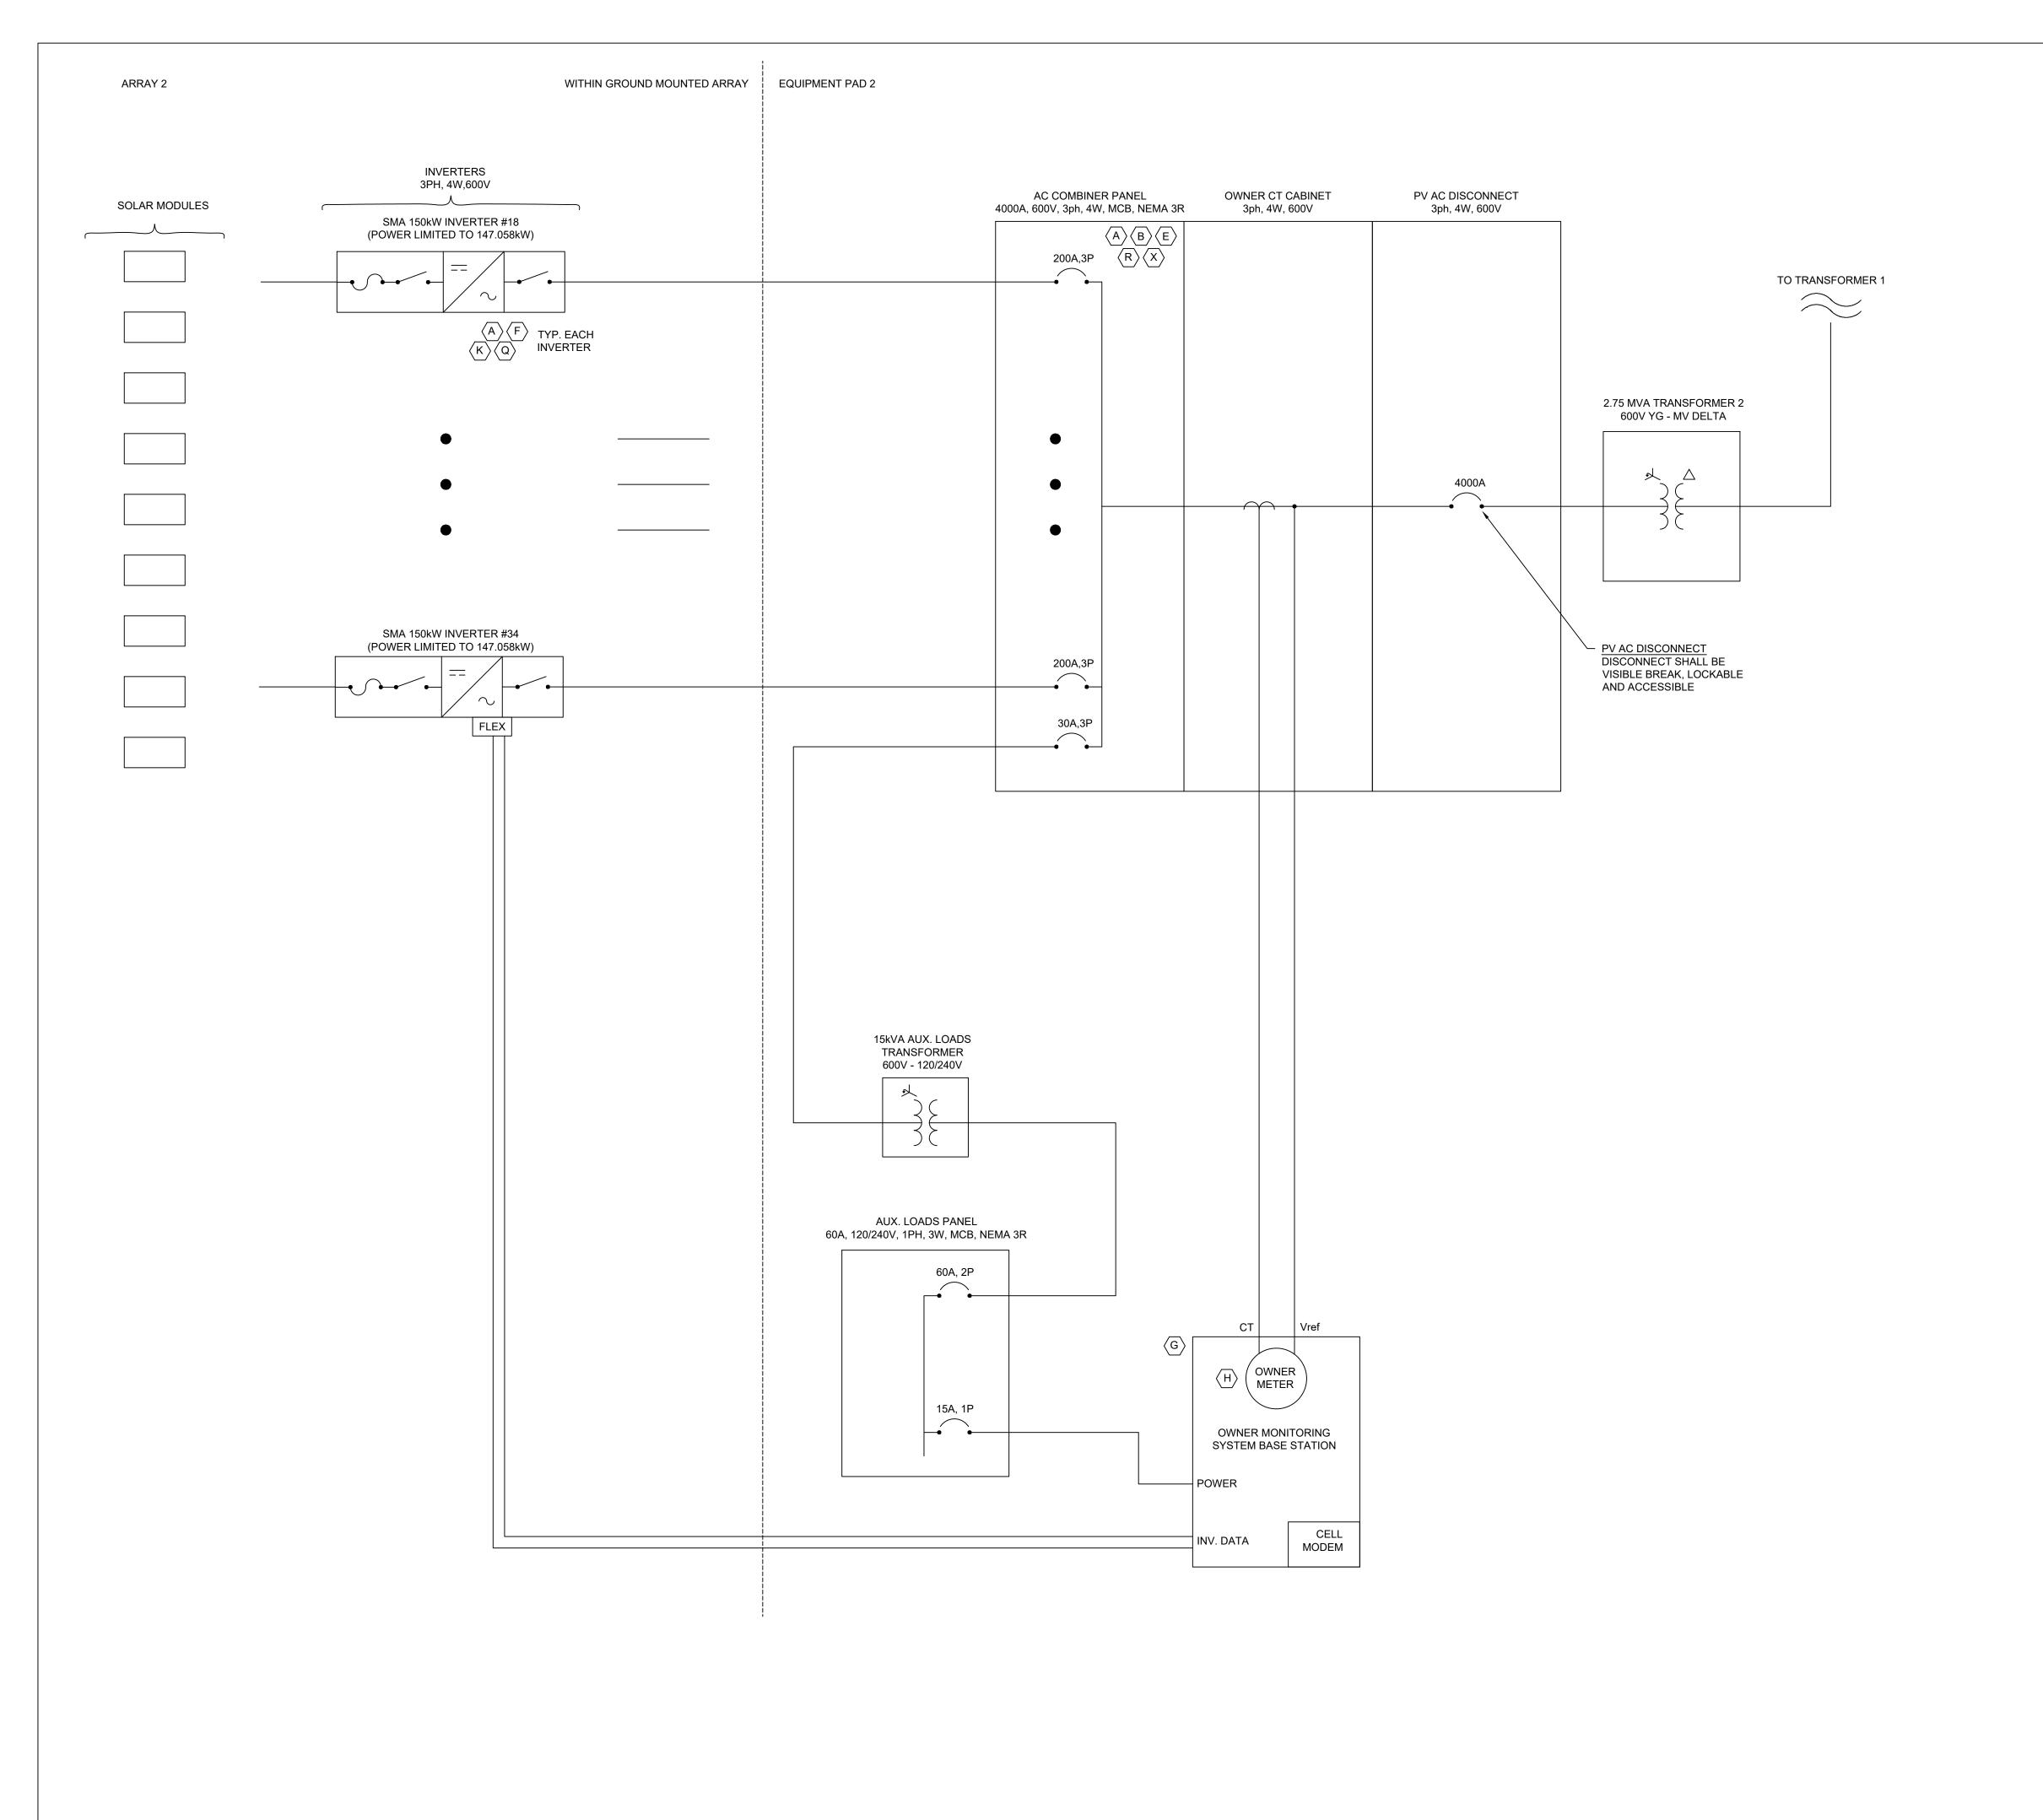



NOTE: SMA INVERTERS ARE UL1741 CERTIFIED



PROJECT ENTITY: WILD CAT SOLAR 4 LLC - SICILIANO

NEW ENERGY EQUITY, LLC 2530 RIVA ROAD, SUITE 200 ANNAPOLIS, MD 21041 NEWENERGYEQUITY.COM 443-267-5012

PROJECT ADDRESS 28964 S PARK AVE

LAT: 41.365 LONG: -87.602 BEECHER, IL 60401

SYSTEM SPECIFICATIONS		
SYSTEM SIZE DC 7.378 MW		
SYSTEM SIZE AC	POWER LIMITED TO 5.000 MW	
DC/AC RATIO	1.476	
AZIMUTH	180°	
TILT	+/- 52°	
MODULE COUNT	12720	
MODULE TYPE	HANWHA Q.PEAK DUO XL-G11.3/BFG	
MODULE STC RATING	580 W	
INVERTER COUNT	34	
INVERTER TYPE	SMA SUNNY HIGHPOWER PEAK-: 150kW	
INVERTER POWER	POWER LIMITED TO 147.058 kW	
RACKING	TBD	
MONITORING	ALSO ENERGY	

	DESIGN CRITERIA		
MIN/MAX TEMP22°C / 33°C		-22°C / 33°C	
	WIND SPEED (ASCE 7-10)	105 MPH	
	BUILDING CATEGORY	I	
	EXPOSURE CATEGORY	С	
	GROUND SNOW LOAD	25 PSF	
	BUILDING HEIGHT	0'-0"	

OTHER NOTES E-911 ADDRESS TO BE APPLIED FOR WITH BUILDING PERMIT

NO POSITION, DISTANCE, OR CLEARANCE ISSUES WITH OVERHEAD ELECTRIC SERVICE LINES OR OTHER UTILITIES IN RELATION TO THE PV PANELS.

24/7 UNESCORTED KEYLESS ACCESS PROVIDED FOR ALL UTILITY ENERGY EQUIPMENT INCLUDING THE METERS AND AC DISCONNECT.

INTERCONNECTION TYPE: PRIMARY

	REVISIONS				
# DESCRIPTION		BY	DATE		
0	ORIGINAL DESIGN	SP	3/20/2023		
1	CUP PACKAGE	SP	3/22/2023		
2	ACCESS RD CHANGE	SP	4/5/2023		
3	1.55 DC/AC RATIO CHANGE	SP	12/7/2023		
4	SLD WYE-DELTA WYE	SP	3/14/2024		
5	CUP REFRESH	SP	4/30/2024		
6	GAS LINE ADDITION	SP	5/9/2024		
7	VISUAL SCREENING PAGES	SP	5/28/2024		
8					
9					
10					
11					

PROJECT NAME


SICILIANO


DRAWING TITLE


SINGLE LINE

SCALE 1

SHEET

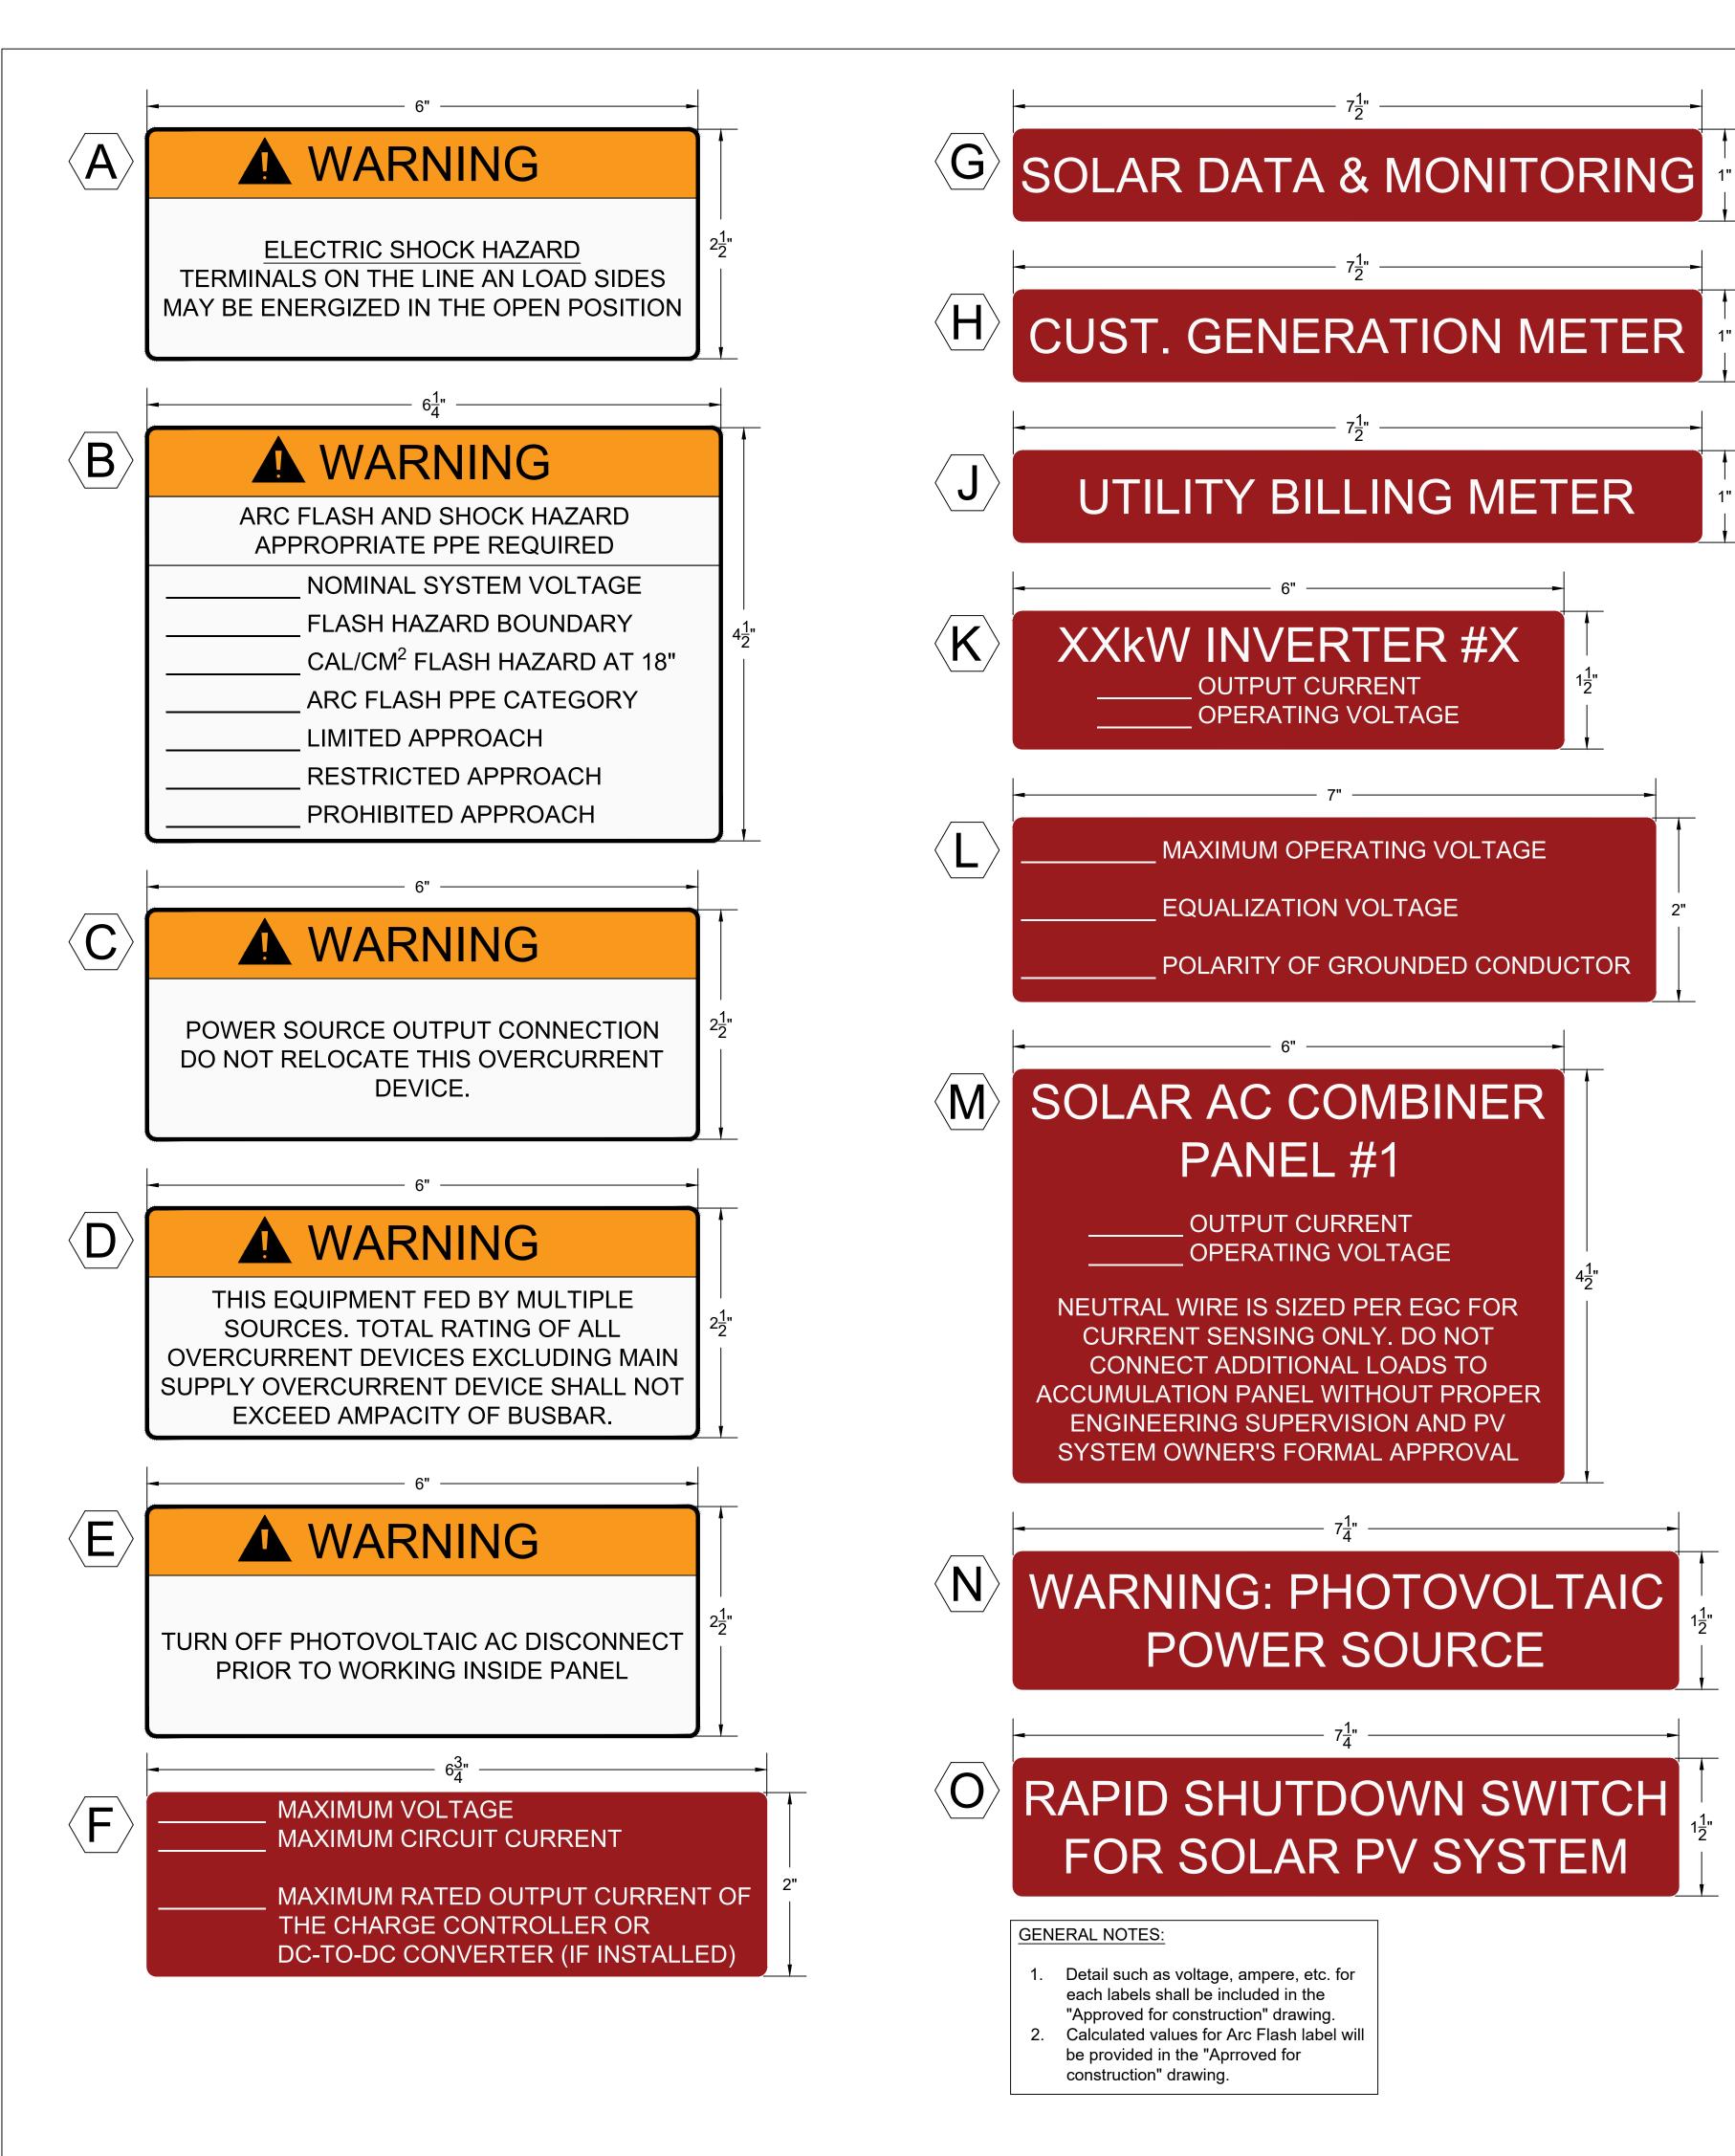

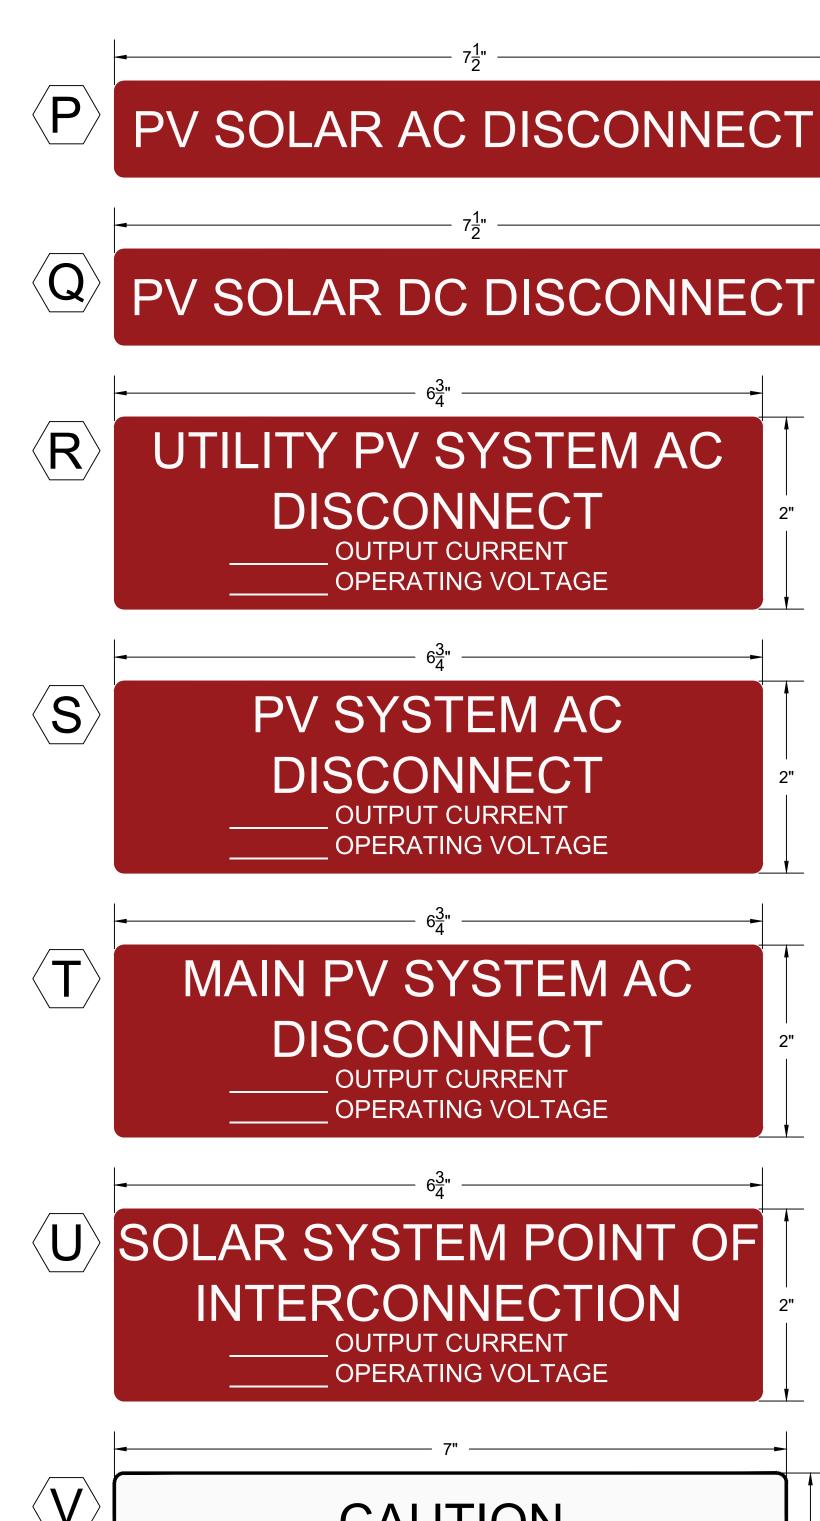

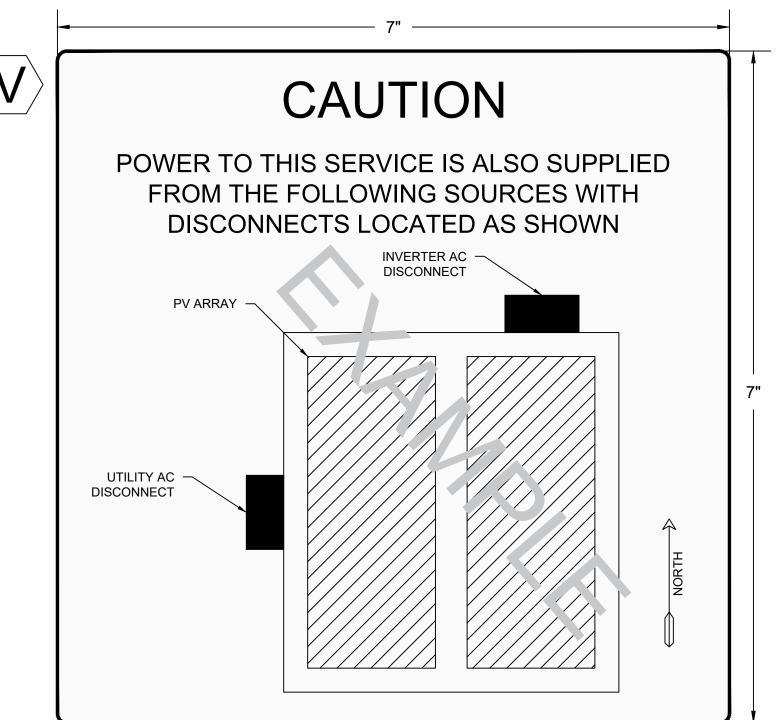



NEW ENERGY EQUITY, LLC 2530 RIVA ROAD, SUITE 200 ANNAPOLIS, MD 21041 NEWENERGYEQUITY.COM 443-267-5012

PROJECT ADDRESS 28964 S PARK AVE BEECHER, IL 60401

LAT: 41.365 LONG: -87.602

SYSTEM SPECIFICATIONS		
SYSTEM SIZE DC	7.378 MW	
SYSTEM SIZE AC	POWER LIMITED TO 5.000 MV	
DC/AC RATIO	1.476	
AZIMUTH	180°	
TILT	+/- 52°	
MODULE COUNT	12720	
MODULE TYPE	HANWHA Q.PEAK DUO XL-G11.3/BFG	
MODULE STC RATING	580 W	
INVERTER COUNT	34	
INVERTER TYPE	SMA SUNNY HIGHPOWER PEA 150kW	
INVERTER POWER	POWER LIMITED TO 147.058 k	
RACKING	TBD	
MONITORING	ALSO ENERGY	

	DESIGN CRITERIA		
ľ	MIN/MAX TEMP.	-22°C / 33°C	
	WIND SPEED (ASCE 7-10)	105 MPH	
	BUILDING CATEGORY	I	
	EXPOSURE CATEGORY	С	
	GROUND SNOW LOAD	25 PSF	
	BUILDING HEIGHT	0'-0"	

OTHER NOTES
E-911 ADDRESS TO BE APPLIED FOR WITH
BUILDING PERMIT

NO POSITION, DISTANCE, OR CLEARANCE ISSUES WITH OVERHEAD ELECTRIC SERVICE LINES OR OTHER UTILITIES IN RELATION TO THE PV PANELS.

24/7 UNESCORTED KEYLESS ACCESS PROVIDED FOR ALL UTILITY ENERGY EQUIPMENT INCLUDING THE METERS AND AC DISCONNECT.

INTERCONNECTION TYPE: PRIMARY

	REVISIONS				
#	DESCRIPTION	BY	DATE		
0	ORIGINAL DESIGN	SP	3/20/2023		
1	CUP PACKAGE	SP	3/22/2023		
2	ACCESS RD CHANGE	SP	4/5/2023		
3	1.55 DC/AC RATIO CHANGE	SP	12/7/2023		
4	SLD WYE-DELTA WYE	SP	3/14/2024		
5	CUP REFRESH	SP	4/30/2024		
6	GAS LINE ADDITION	SP	5/9/2024		
7	VISUAL SCREENING PAGES	SP	5/28/2024		
8					
9					
10					
11					

PROJECT NAME
SICILIANO

DRAWING TITLE


SYSTEM LABELS A

SCALE 1

NITS

SHEET

E2A

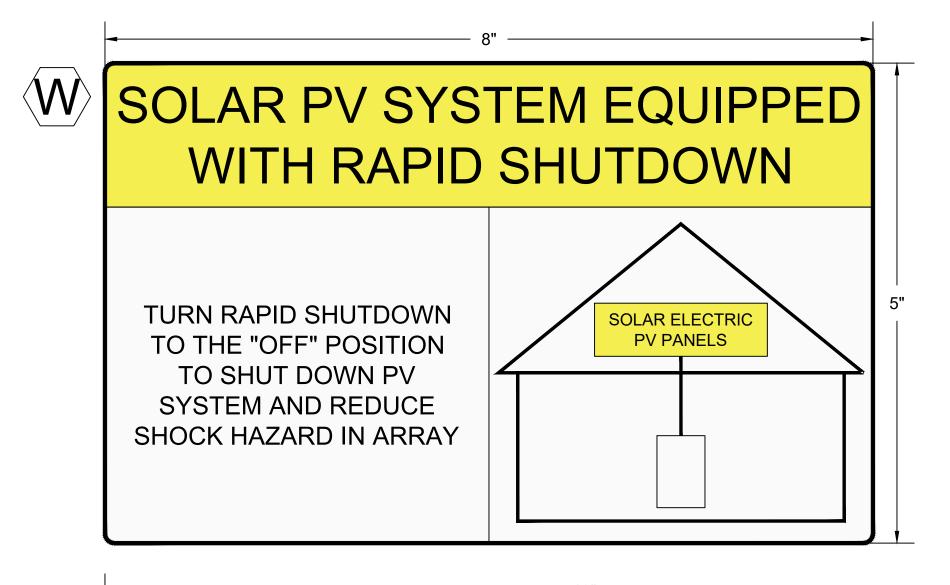

MARNING DUAL POWER SOURCE

SECOND SOURCE IS PV SYSTEM



GENERAL NOTES:

- (1) ALL LABELS MUST COMPLY WITH 2020 NEC 110.21(B):
- (2) LABELS AS PROVIDED AND NOTED ON THIS SHEET MEET WARNING, EFFECTIVE WORDING AND COLOR/SYMBOL REQUIREMENTS
- (3) LABELS SHALL BE PERMANENTLY AFFIXED TO EQUIPMENT OR WIRING METHOD
- (4) LABELS SHALL BE OF SUFFICIENT DURABILITY TO WITHSTAND THE ENVIRONMENT INVOLVED. STICKERS OF PROPER DURABILITY AND ADHESION ARE PREFERRED. REFERENCE ANSI Z535.4-2011 FOR GUIDELINES.

SPECIFIC LABEL NOTES:

- A. 2020 NEC 690.13(D)
- B. 2020 NEC 110.16
- C. 2020 NEC 705.12(B)(1)(b)
- D. 2020 NEC 110.27(C)
- E. 2020 NEC 110.27(C)
- F. 2020 NEC 690.53
- G. UTILITY REQUIREMENT
- H. UTILITY REQUIREMENT
- I. LABEL REMOVED
- J. UTILITY REQUIREMENT
- K. 2020 NEC 690.54
- L. 2020 NEC 690.55
- M. LABEL FOR ACCUMULATION PANEL
- N. 2020 NEC 690.31(F)
- O. 2020 NEC 690.56(C)
- P. 2020 NEC 690.13(B)
- Q. 2020 NEC 690.13(B)
- R. 2020 NEC 690.54S. 2020 NEC 690.54
- 3. 2020 NEC 090.34
- T. 2020 NEC 690.13(B)
- U. LABEL FOR POINT OF INTERCONNECTION
- V. 2020 NEC 705.10 SYSTEM PLACCARD
- W. 2020 NEC 690.56(C)(1)
- X. 2020 NEC 690.59

EQUIPMENT	LABELS
ACCUMULATION PANELS, COMBINER BOXES, PULL BOXES, ENCLOSURES	A, B, E, M
DC CONDUIT	N
RAPID SHUTDOWN	O, W
ENERGY STORAGE	L
INVERTERS	K
MONITORING EQUIPMENT	G
METERS	H, J, X
DC DISCONNECT	A, F, Q
AC DISCONNECT	A, B, E, O, P, R, S, T, X
POINT OF INTERCONNECTION	A, C, D, U, V, E



PROJECT ENTITY: WILD CAT SOLAR 4 LLC - SICILIANO

NEW ENERGY EQUITY, LLC 2530 RIVA ROAD, SUITE 200 ANNAPOLIS, MD 21041 NEWENERGYEQUITY.COM 443-267-5012

PROJECT ADDRESS 28964 S PARK AVE BEECHER, IL 60401

LAT: 41.365 LONG: -87.602

SYSTEM SPECIFICATIONS			
SYSTEM SIZE DC	7.378 MW		
SYSTEM SIZE AC	POWER LIMITED TO 5.000 MW		
DC/AC RATIO	1.476		
AZIMUTH	180°		
TILT	+/- 52°		
MODULE COUNT	12720		
MODULE TYPE	HANWHA Q.PEAK DUO XL-G11.3/BFG		
MODULE STC RATING	580 W		
INVERTER COUNT	34		
INVERTER TYPE	SMA SUNNY HIGHPOWER PEAK- 150kW		
INVERTER POWER	POWER LIMITED TO 147.058 kW		
RACKING	TBD		
MONITORING	ALSO ENERGY		

	DESIGN CRITERIA		
MIN/MAX TEMP22°C / 33°C			
	WIND SPEED (ASCE 7-10)	105 MPH	
	BUILDING CATEGORY	I	
	EXPOSURE CATEGORY	С	
	GROUND SNOW LOAD	25 PSF	
	BUILDING HEIGHT	0'-0"	
(·	<u> </u>	

OTHER NOTES
E-911 ADDRESS TO BE APPLIED FOR WITH
BUILDING PERMIT

NO POSITION, DISTANCE, OR CLEARANCE ISSUES WITH OVERHEAD ELECTRIC SERVICE LINES OR OTHER UTILITIES IN RELATION TO THE PV PANELS.

24/7 UNESCORTED KEYLESS ACCESS PROVIDED FOR ALL UTILITY ENERGY EQUIPMENT INCLUDING THE METERS AND AC DISCONNECT.

INTERCONNECTION TYPE: PRIMARY

REVISIONS			
#	DESCRIPTION	BY	DATE
0	ORIGINAL DESIGN	SP	3/20/20
1	CUP PACKAGE	SP	3/22/20
2	ACCESS RD CHANGE	SP	4/5/202
3	1.55 DC/AC RATIO CHANGE	SP	12/7/202
4	SLD WYE-DELTA WYE	SP	3/14/20
5	CUP REFRESH	SP	4/30/20
6	GAS LINE ADDITION	SP	5/9/202
7	VISUAL SCREENING PAGES	SP	5/28/20
8			
9			
10			
11			

PROJECT NAME

SICILIANO

DRAWING TITLE


SYSTEM LABELS B

SCALE 1

NTS

SHEE

E2B

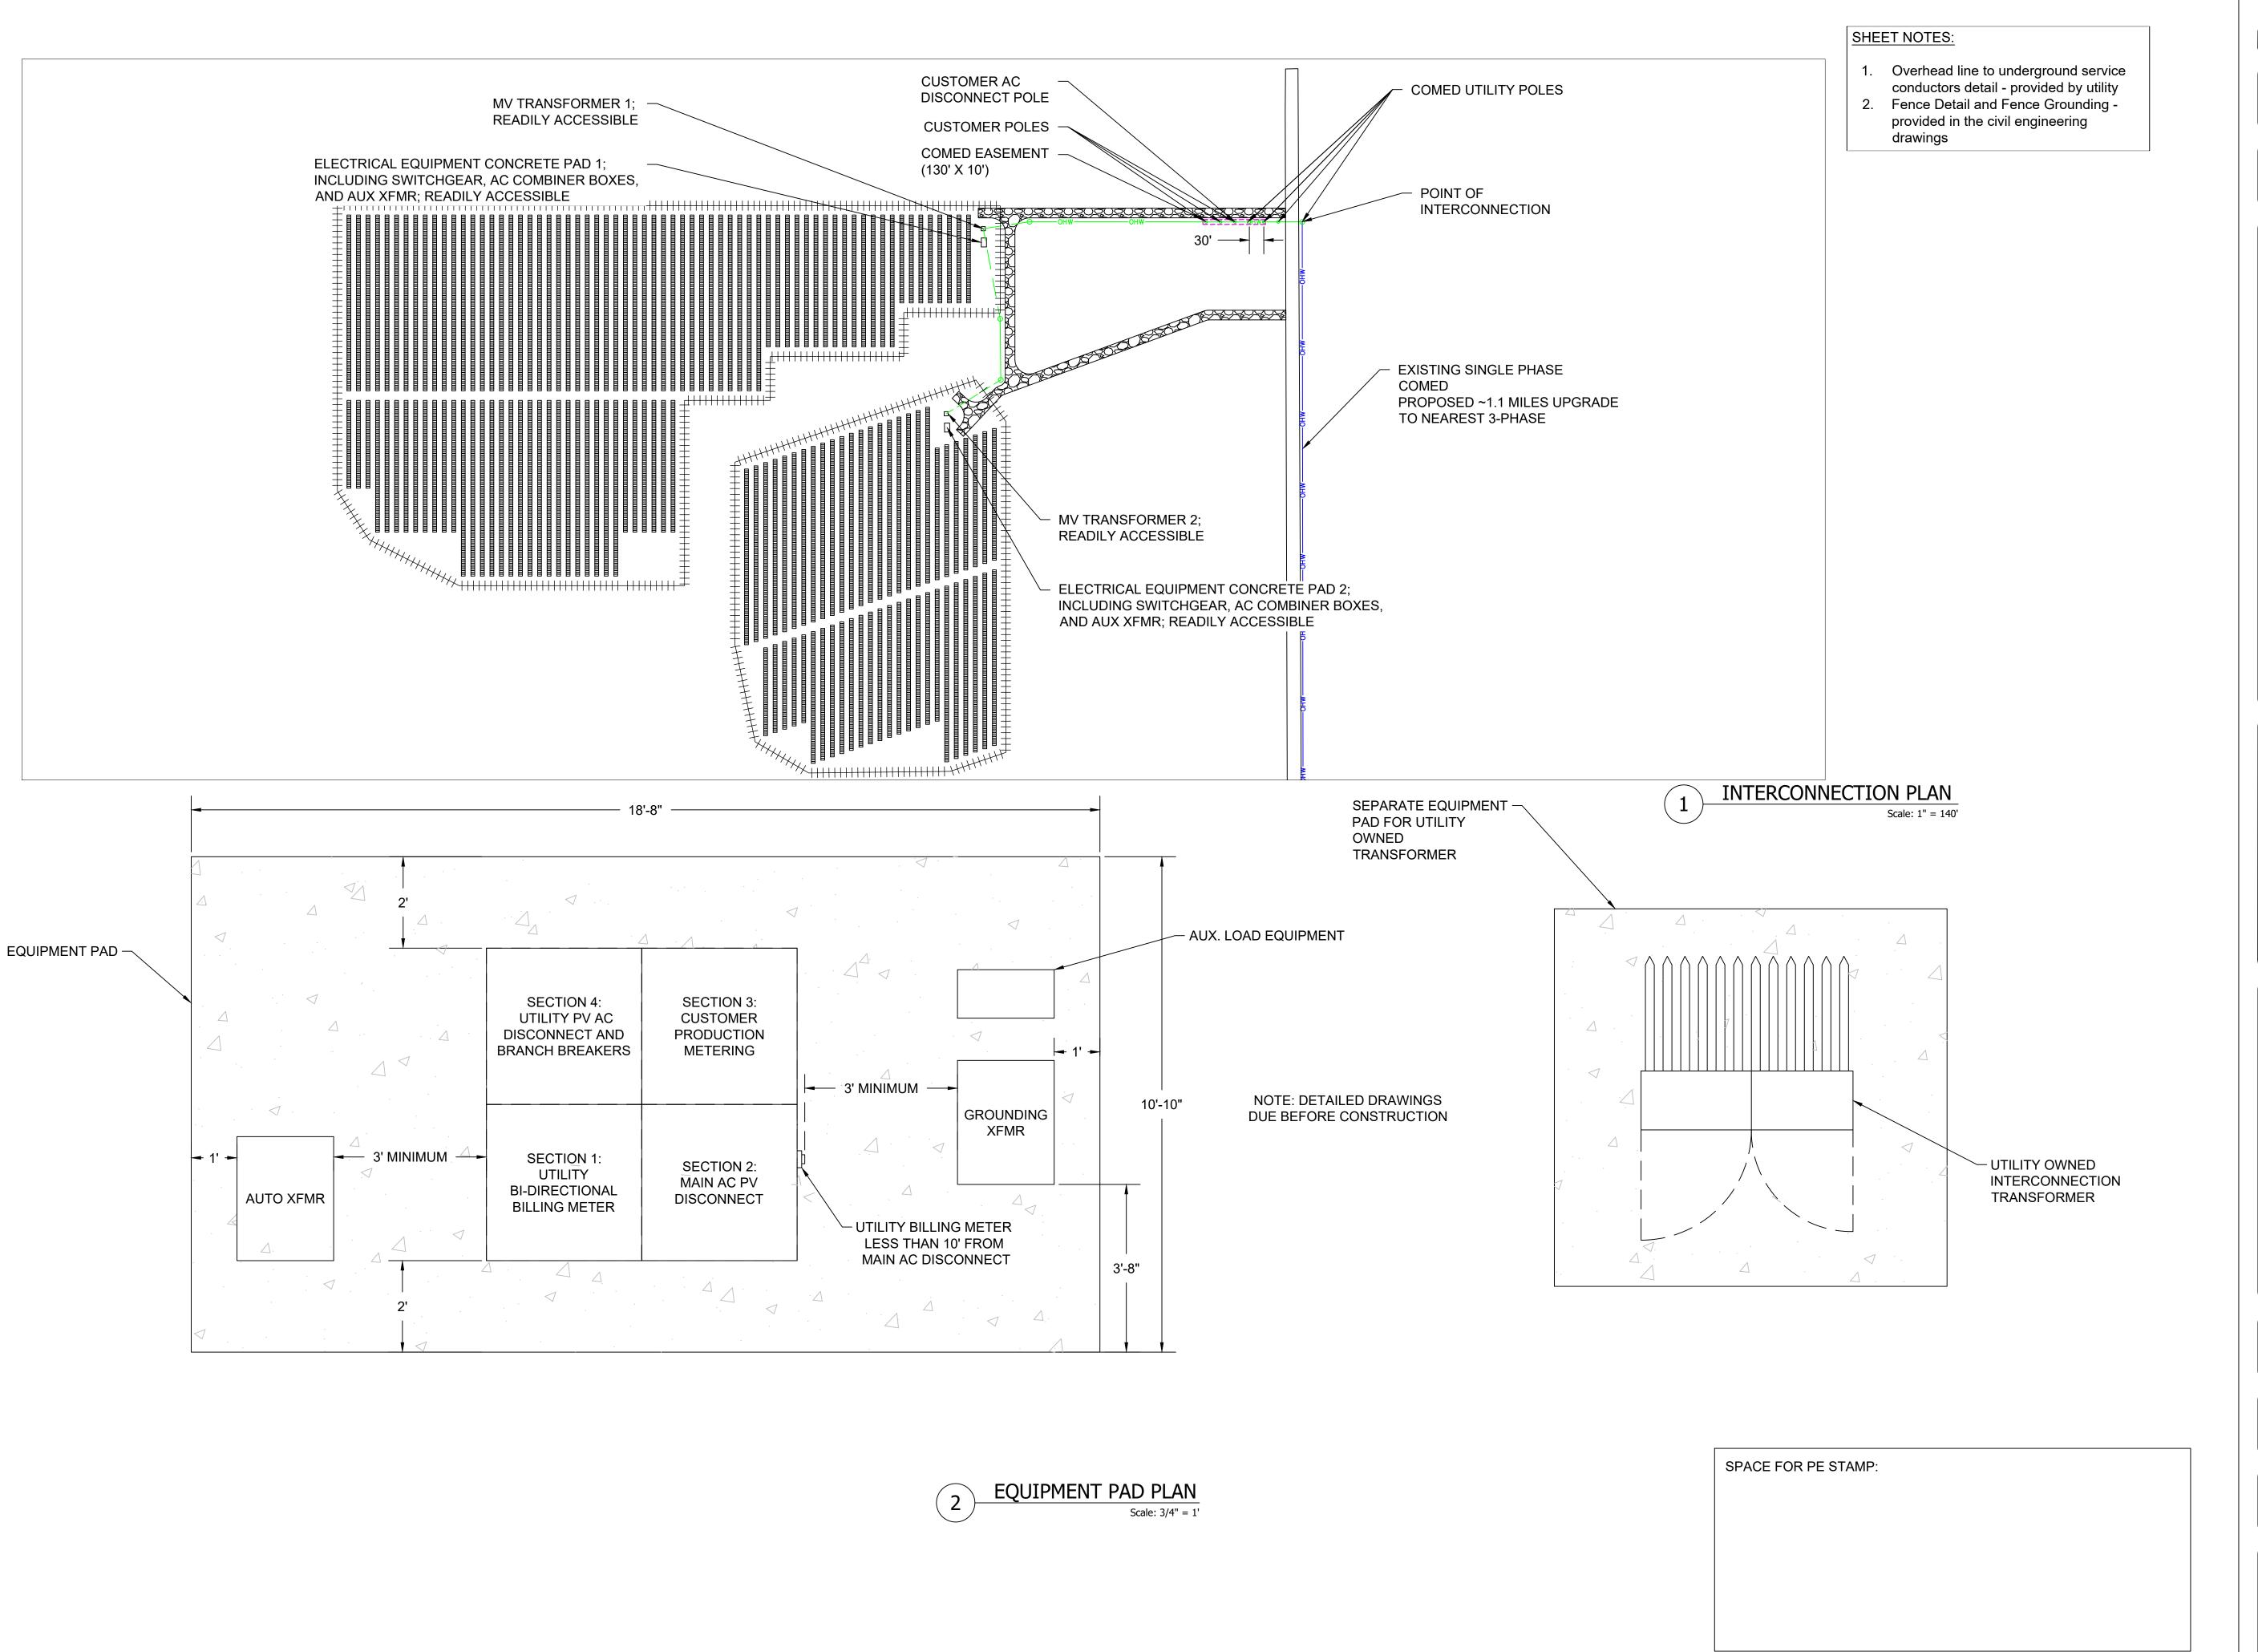



NEW ENERGY EQUITY, LLC 2530 RIVA ROAD, SUITE 200 ANNAPOLIS, MD 21041 NEWENERGYEQUITY.COM 443-267-5012

PROJECT ADDRESS 28964 S PARK AVE

LAT: 41.365 LONG: -87.602 BEECHER, IL 60401

SYSTEM SPECIFICATIONS			
SYSTEM SIZE DC	7.378 MW		
SYSTEM SIZE AC	POWER LIMITED TO 5.000 MW		
DC/AC RATIO	1.476		
AZIMUTH	180°		
TILT	+/- 52°		
MODULE COUNT	12720		
MODULE TYPE	HANWHA Q.PEAK DUO XL-G11.3/BFG		
MODULE STC RATING	580 W		
INVERTER COUNT	34		
INVERTER TYPE	SMA SUNNY HIGHPOWER PEAK- 150kW		
INVERTER POWER	POWER LIMITED TO 147.058 kW		
RACKING	TBD		
MONITORING	ALSO ENERGY		

DESIGN CRITERIA				
MIN/MAX TEMP22°C / 33°C				
WIND SPEED (ASCE 7-10)	105 MPH			
BUILDING CATEGORY	I			
EXPOSURE CATEGORY	С			
GROUND SNOW LOAD	25 PSF			
BUILDING HEIGHT	0'-0"			
	MIN/MAX TEMP. WIND SPEED (ASCE 7-10) BUILDING CATEGORY EXPOSURE CATEGORY GROUND SNOW LOAD			

OTHER NOTES E-911 ADDRESS TO BE APPLIED FOR WITH **BUILDING PERMIT**

NO POSITION, DISTANCE, OR CLEARANCE ISSUES WITH OVERHEAD ELECTRIC SERVICE LINES OR OTHER UTILITIES IN RELATION TO THE PV PANELS.

24/7 UNESCORTED KEYLESS ACCESS PROVIDED FOR ALL UTILITY ENERGY EQUIPMENT INCLUDING THE METERS AND AC DISCONNECT.

INTERCONNECTION TYPE: PRIMARY

REVISIONS			
#	DESCRIPTION	BY	DATI
0	ORIGINAL DESIGN	SP	3/20/20
1	CUP PACKAGE	SP	3/22/20
2	ACCESS RD CHANGE	SP	4/5/20
3	1.55 DC/AC RATIO CHANGE	SP	12/7/20
4	SLD WYE-DELTA WYE	SP	3/14/20
5	CUP REFRESH	SP	4/30/20
6	GAS LINE ADDITION	SP	5/9/20
7	VISUAL SCREENING PAGES	SP	5/28/20
8			
9			
10			
11			

PROJECT NAME

SICILIANO

DRAWING TITLE


ELECTRICAL DETAILS


SCALE 1

AS NOTED

<u>SHEET</u>



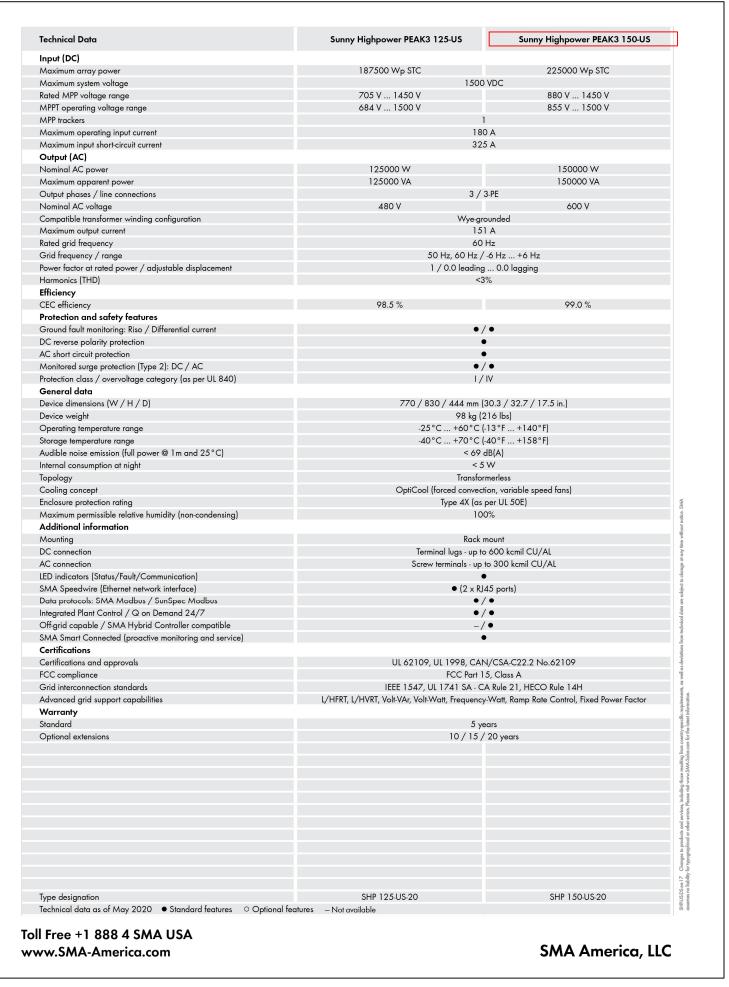

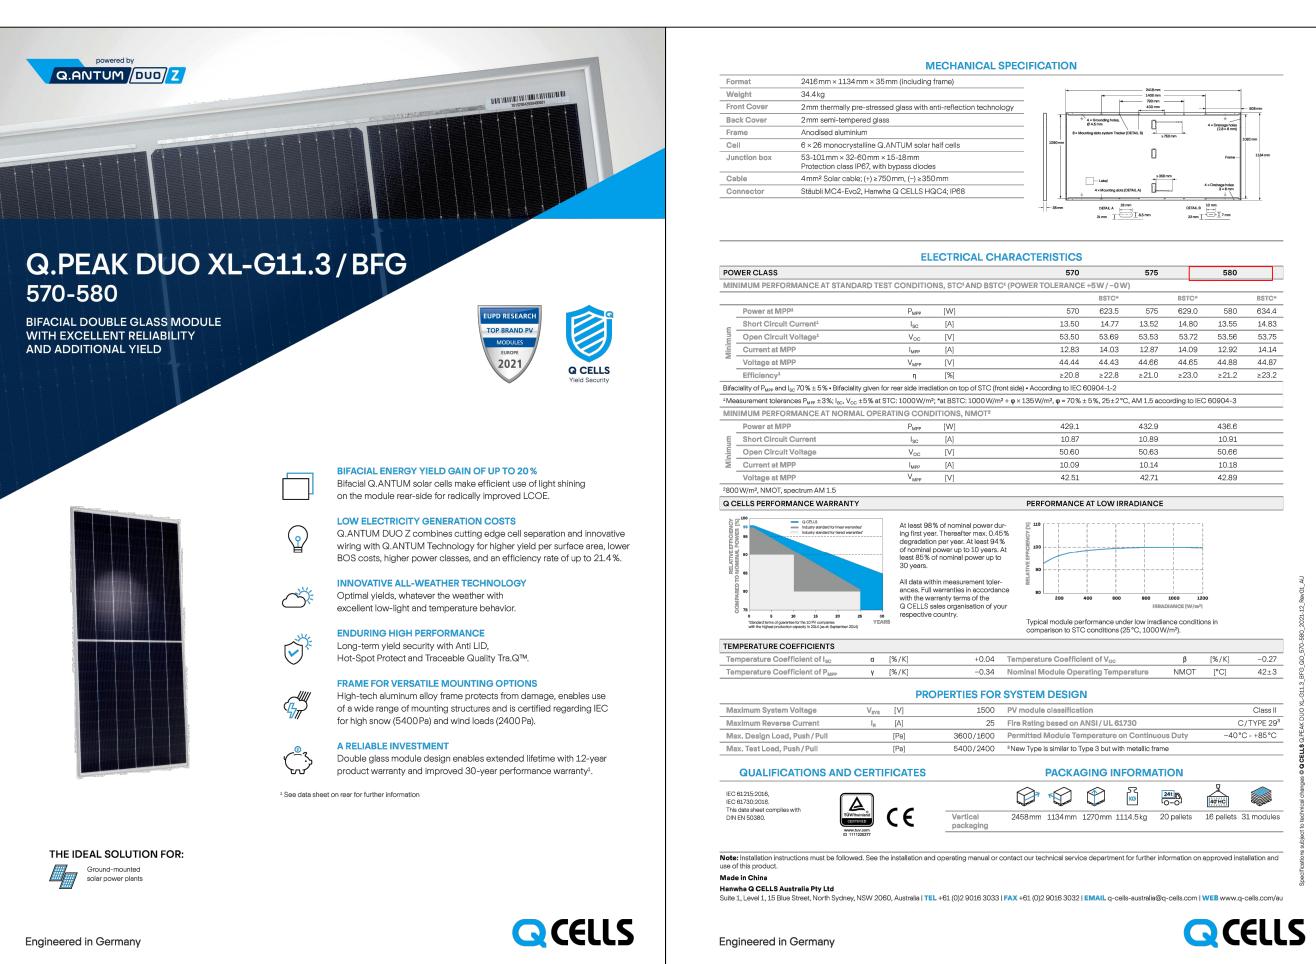



NEW ENERGY EQUITY, LLC 2530 RIVA ROAD, SUITE 200 ANNAPOLIS, MD 21041 NEWENERGYEQUITY.COM 443-267-5012

PROJECT ADDRESS 28964 S PARK AVE BEECHER, IL 60401

LAT: 41.365 LONG: -87.602

SYSTEM SPECIFICATIONS			
SYSTEM SIZE DC	7.378 MW		
SYSTEM SIZE AC	POWER LIMITED TO 5.000 MV		
DC/AC RATIO	1.476		
AZIMUTH	180°		
TILT	+/- 52°		
MODULE COUNT	12720		
MODULE TYPE	HANWHA Q.PEAK DUO XL-G11.3/BFG		
MODULE STC RATING	580 W		
INVERTER COUNT	34		
INVERTER TYPE	SMA SUNNY HIGHPOWER PEAI 150kW		
INVERTER POWER	POWER LIMITED TO 147.058 k		
RACKING	TBD		
MONITORING	ALSO ENERGY		

DESIGN CRITERIA			
MIN/MAX TEMP22°C / 33°C			
WIND SPEED (ASCE 7-10)	105 MPH		
BUILDING CATEGORY	1		
EXPOSURE CATEGORY	С		
GROUND SNOW LOAD	25 PSF		
BUILDING HEIGHT	0'-0"		

OTHER NOTES
E-911 ADDRESS TO BE APPLIED FOR WITH
BUILDING PERMIT

NO POSITION, DISTANCE, OR CLEARANCE ISSUES WITH OVERHEAD ELECTRIC SERVICE LINES OR OTHER UTILITIES IN RELATION TO THE PV PANELS.

24/7 UNESCORTED KEYLESS ACCESS PROVIDED FOR ALL UTILITY ENERGY EQUIPMENT INCLUDING THE METERS AND AC DISCONNECT.

INTERCONNECTION TYPE: PRIMARY

REVISIONS			
#	DESCRIPTION	BY	DATE
0	ORIGINAL DESIGN	SP	3/20/20
1	CUP PACKAGE	SP	3/22/20
2	ACCESS RD CHANGE	SP	4/5/20
3	1.55 DC/AC RATIO CHANGE	SP	12/7/20
4	SLD WYE-DELTA WYE	SP	3/14/20
5	CUP REFRESH	SP	4/30/20
6	GAS LINE ADDITION	SP	5/9/20
7	VISUAL SCREENING PAGES	SP	5/28/20
8			
9			
10			
11			

PROJECT NAME

SICILIANO

DRAWING TITLE

EQUIPMENT DOCUMENTS 1

SCALE 1

NTS

SHEET

Ξ4



Certificate of Compliance

Certificate: 80048527

Master Contract: 254141

Project:

Hanwha Q.CELLS GmbH

17-21 Sonnenallee Thalheim Bitterfeld-Wolfen, Sachsen-Anhalt, 06766

Attention: Wiebke Engler

The products listed below are eligible to bear the CSA Mark shown with adjacent indicators 'C' and 'US' for Canada and US or with adjacent indicator 'US' for US only or without either indicator for Canada only.



Tom Yang **Issued by:** Tom Yang

PRODUCTS

CLASS - C531110 - POWER SUPPLIES Photovoltaic Modules and Panels CLASS - C531190 - POWER SUPPLIES Photovoltaic Modules and Panels - Certified to US Standards


Photovoltaic Modules with Maximum System Voltage of 1000 V dc or 1500 V dc, Class II / Application Class A, Fire Resistance Class C, Module Fire Performance Type 1, Type 2 or Type 5 (for US). Module Types: Q.PLUS L-G4.2 XXX (XXX = 305 to 375, in steps of 5W),

B.LINE PLUS L-G4.2 XXX (XXX = 305 to 375, in steps of 5W), Q.PLUS BFR-G4.1 XXX (XXX = 270 to 295, in steps of 5W and 282W), B.LINE PLUS BFR-G4.1 XXX (XXX = 270 to 295, in steps of 5W and 282W), Q.PLUS DUO L-G5.2 XXX (XXX = 340 to 385, in steps of 5W),

B.LINE PLUS DUO L-G5.2 XXX (XXX = 340 to 385, in steps of 5W),

Q.PEAK DUO L-G5 XXX (XXX = 360 to 425, in steps of 5W),

© 2022 CSA Group. All rights reserved

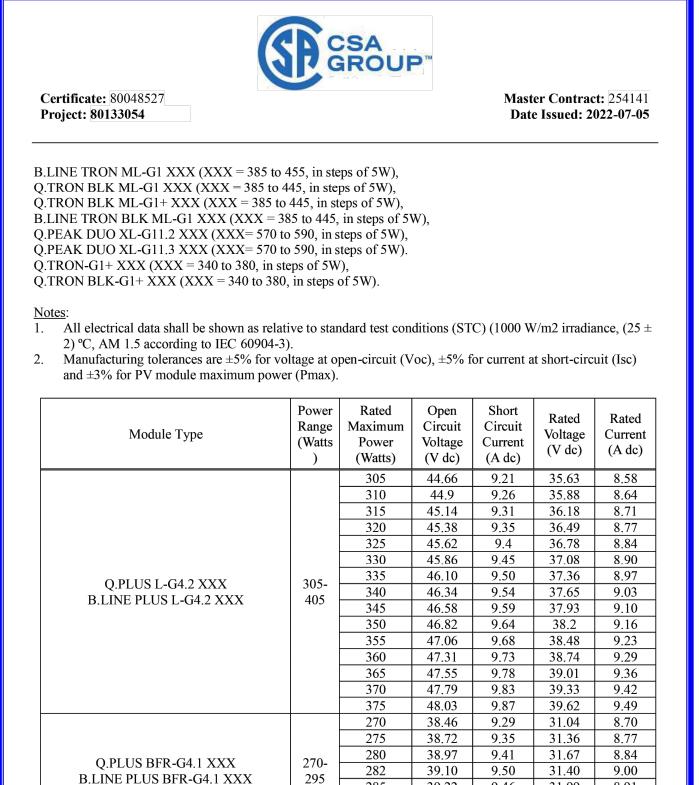



 Q.PLUS DUO L-G5.2 XXX
 340 340 340 45.89
 9.69
 37.40
 9.09


 B.LINE PLUS DUO L-G5.2 XXX
 385
 345
 46.11
 9.73
 37.68
 9.16

© 2022 CSA Group. All rights reserved.

DQD 507 Rev. 2019-04-30

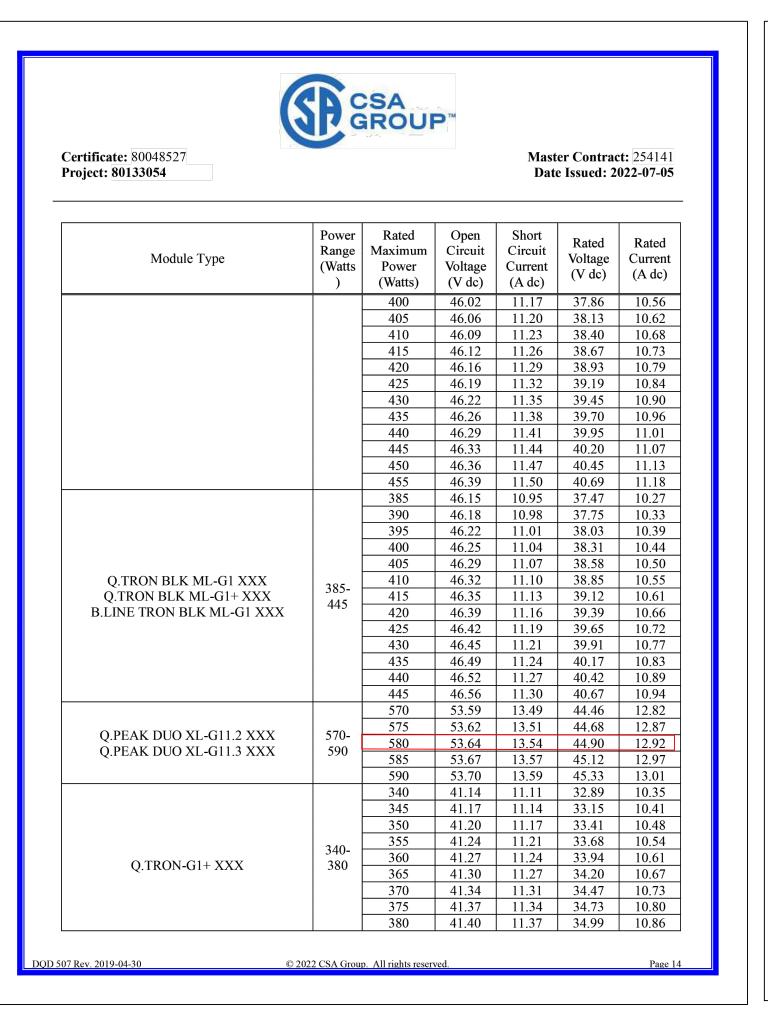

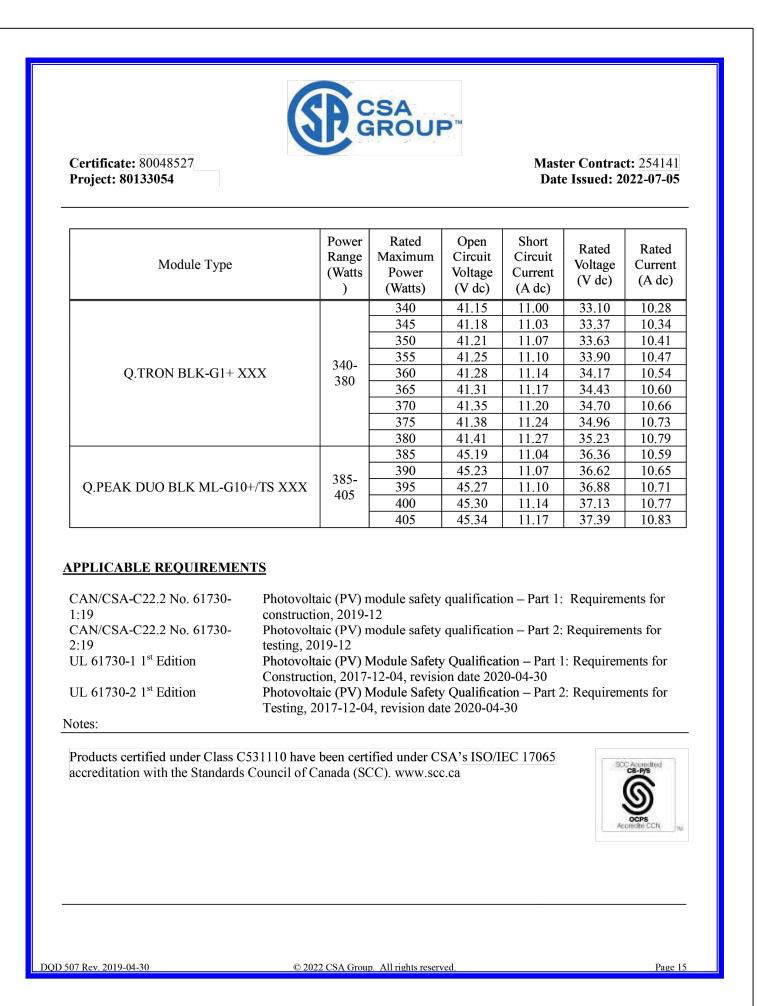

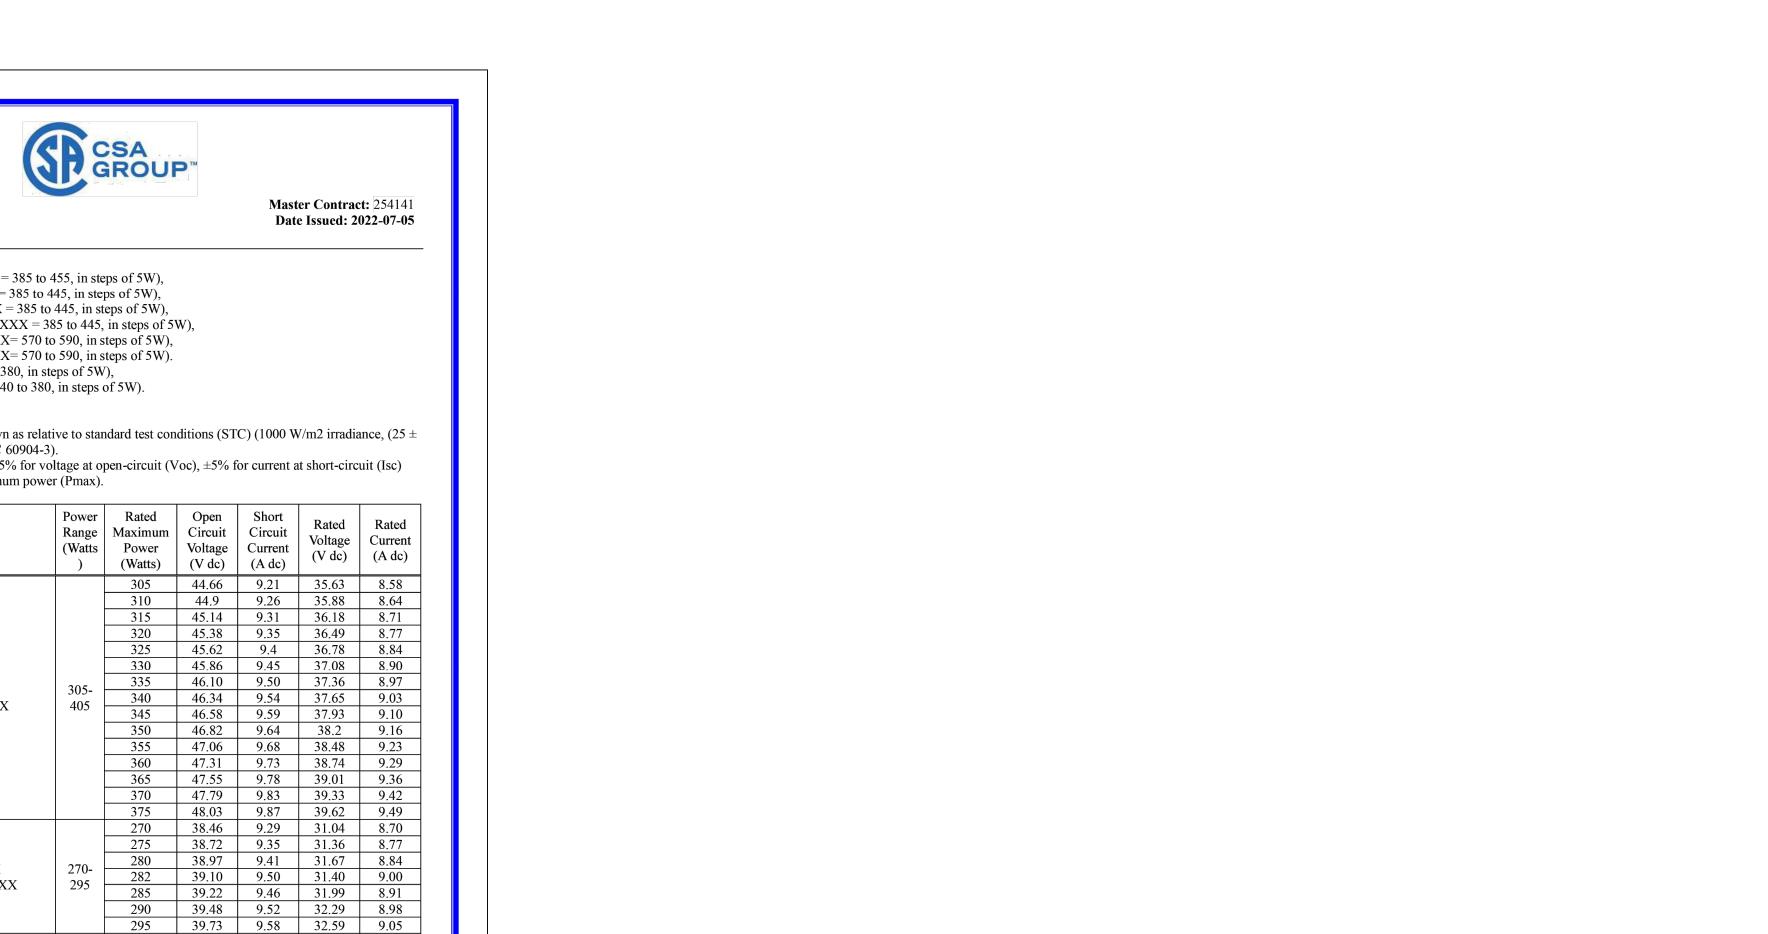

GROUND SNOW LOAD 25 PSF BUILDING HEIGHT 0'-0" OTHER NOTES E-911 ADDRESS TO BE APPLIED FOR WITH

NEW ENERGY

PROJECT ENTITY: WILD CAT SOLAR 4 LLC - SICILIANO

NEW ENERGY EQUITY, LLC 2530 RIVA ROAD, SUITE 200 ANNAPOLIS, MD 21041 NEWENERGYEQUITY.COM

443-267-5012

SYSTEM SPECIFICATIONS

SYSTEM SIZE AC POWER LIMITED TO 5.000 MW

INVERTER POWER | POWER LIMITED TO 147.058 kW

DESIGN CRITERIA

28964 S PARK AVE

BEECHER, IL 60401

SYSTEM SIZE DC

MODULE COUNT

MODULE TYPE

MODULE STC RATING

INVERTER COUNT

INVERTER TYPE

RACKING

MIN/MAX TEMP.

WIND SPEED (ASCE 7-10)

BUILDING CATEGORY

EXPOSURE CATEGORY

BUILDING PERMIT

MONITORING

DC/AC RATIO

AZIMUTH

TILT

LAT: 41.365

LONG: -87.602

180°

+/- 52°

12720

HANWHA Q.PEAK DUO

XL-G11.3/BFG

580 W

34

SMA SUNNY HIGHPOWER PEAK-3

TBD

ALSO ENERGY

-22°C / 33°C

105 MPH

NO POSITION, DISTANCE, OR CLEARANCE ISSUES WITH OVERHEAD ELECTRIC SERVICE LINES OR OTHER UTILITIES IN RELATION TO THE PV PANELS.

24/7 UNESCORTED KEYLESS ACCESS PROVIDED FOR ALL UTILITY ENERGY EQUIPMENT INCLUDING THE METERS AND AC DISCONNECT.

INTERCONNECTION TYPE: PRIMARY

REVISIONS			
#	DESCRIPTION	BY	DATE
0	ORIGINAL DESIGN	SP	3/20/20
1	CUP PACKAGE	SP	3/22/20
2	ACCESS RD CHANGE	SP	4/5/20
3	1.55 DC/AC RATIO CHANGE	SP	12/7/20
4	SLD WYE-DELTA WYE	SP	3/14/20
5	CUP REFRESH	SP	4/30/20
6	GAS LINE ADDITION	SP	5/9/20
7	VISUAL SCREENING PAGES	SP	5/28/20
8			
9			
10			
11			

PROJECT NAME SICILIANO

DRAWING TITLE

EQUIPMENT DOCUMENTS 2

SCALE 1

SPACE FOR PE STAMP:

SHEET

CERTIFICATE OF COMPLIANCE

Certificate Number 20190417-E210376 Report Reference E210376-20190328 Issue Date 2019-APRIL-17

> Issued to: SMA Solar Technology AG Sonnenallee 1 34266 Niestetal GERMANY

representative samples of

This certificate confirms that STATIC INVERTERS, CONVERTERS AND ACCESSORIES FOR USE IN INDEPENDENT POWER

SYSTEMS

Permanently-connected, utility Interactive, 3-phase inverter, Models: SHP 150-US-20, SHP 125-US-20. (which are intended for DC input from photovoltaic modules)

Have been investigated by UL in accordance with the Standard(s) indicated on this Certificate.

Standard(s) for Safety: Please see addendum page

Additional Information: See the UL Online Certifications Directory at https://iq.ulprospector.com for additional information.

This Certificate of Compliance does not provide authorization to apply the UL Mark. Only the UL Follow-Up Services Procedure provides authorization to apply the UL Mark.

Only those products bearing the UL Mark should be considered as being UL Certified and covered under UL's Follow-Up Services.

Look for the UL Certification Mark on the product.

Any information and documentation involving UL Mark services are provided on behalf of UL LLC (UL) or any authorized licensee of UL. For questions, please contact a local UL Customer Service Representative at http://ul.com/aboutul/locations/

CERTIFICATE OF COMPLIANCE

Certificate Number 20190417-E210376 Report Reference E210376-20190328 Issue Date 2019-APRIL-17

This is to certify that representative samples of the product as specified on this certificate were tested according to the current UL requirements.

Standard(s) for Safety:

UL 62109-1, Safety of power converters for use in photovoltaic power systems – Part 1: General

CSA C22.2 No. 62109-1 Safety of power converters for use in photovoltaic power systems - Part 1: General requirements.

CSA C22.2 No. 62109-2 Safety of power converters for use in photovoltaic power systems - Part 2: Particular requirements for inverters.

Any information and documentation involving UL Mark services are provided on behalf of UL LLC (UL) or any authorized licensee of UL. For questions, please contact a local UL Customer Service Representative at http://ul.com/aboutul/locations/



PROJECT ENTITY: WILD CAT SOLAR 4 LLC - SICILIANO

NEW ENERGY EQUITY, LLC 2530 RIVA ROAD, SUITE 200 ANNAPOLIS, MD 21041 NEWENERGYEQUITY.COM 443-267-5012

PROJECT ADDRESS 28964 S PARK AVE BEECHER, IL 60401

LAT: 41.365 LONG: -87.602

SYSTEM SPECIFICATIONS				
SYSTEM SIZE DC 7.378 MW				
SYSTEM SIZE AC	POWER LIMITED TO 5.000 MW			
DC/AC RATIO	1.476			
AZIMUTH	180°			
TILT	+/- 52°			
MODULE COUNT	12720			
MODULE TYPE	HANWHA Q.PEAK DUO XL-G11.3/BFG			
MODULE STC RATING	580 W			
INVERTER COUNT	34			
INVERTER TYPE	SMA SUNNY HIGHPOWER PEAK-3 150kW			
INVERTER POWER	POWER LIMITED TO 147.058 kW			
RACKING	TBD			
MONITORING	ALSO ENERGY			

DESIGN CRITERIA				
MIN/MAX TEMP.	-22°C / 33°C			
WIND SPEED (ASCE 7-10)	105 MPH			
BUILDING CATEGORY	I			
EXPOSURE CATEGORY	С			
GROUND SNOW LOAD	25 PSF			
BUILDING HEIGHT	0'-0"			

OTHER NOTES E-911 ADDRESS TO BE APPLIED FOR WITH BUILDING PERMIT

NO POSITION, DISTANCE, OR CLEARANCE ISSUES WITH OVERHEAD ELECTRIC SERVICE LINES OR OTHER UTILITIES IN RELATION TO THE PV PANELS.

24/7 UNESCORTED KEYLESS ACCESS PROVIDED FOR ALL UTILITY ENERGY EQUIPMENT INCLUDING THE METERS AND AC DISCONNECT.

INTERCONNECTION TYPE: PRIMARY

REVISIONS			
#	DESCRIPTION	BY	DATE
0	ORIGINAL DESIGN	SP	3/20/20
1	CUP PACKAGE	SP	3/22/20
2	ACCESS RD CHANGE	SP	4/5/20
3	1.55 DC/AC RATIO CHANGE	SP	12/7/20
4	SLD WYE-DELTA WYE	SP	3/14/20
5	CUP REFRESH	SP	4/30/20
6	GAS LINE ADDITION	SP	5/9/20
7	VISUAL SCREENING PAGES	SP	5/28/20
8			
9			
10			
11			

PROJECT NAME

SICILIANO

DRAWING TITLE

EQUIPMENT DOCUMENTS 3

SCALE 1

SHEET

SPACE FOR PE STAMP:

VILLAGE OF BEECHER, WILL COUNTY, ILLINOIS

ORDINANCE NO.

AN ORDINANCE GRANTING A SPECIAL USE PERMIT FOR 759 W. INDIANA AVENUE UNDER THE ZONING ORDINANCE OF THE VILLAGE OF BEECHER.

WHEREAS, the Corporate Authorities of the Village of Beecher, Will County, Illinois, have received a Special Use Permit application for the property commonly known as 759 W. Indiana Avenue, Beecher, Illinois (hereinafter the "Premises") to allow a U-Haul rental business; and

WHEREAS, the Premises are currently zoned B-1 Historic Downtown District under the Zoning Ordinance of the Village of Beecher (hereinafter the "Village Zoning Ordinance"); and

WHEREAS, pursuant to proper legal notice, the Planning and Zoning Commission of the Village of Beecher conducted a public hearing on the Special Use Permit application on July 25, 2024, and has determined that it would not pose a negative effect on property values in the area nor will it be unreasonably detrimental to the public health, safety or general welfare and has unanimously recommended that the Village Board approve the Petitioner's Special Use Permit subject to conditions; and

WHEREAS, the Corporate Authorities of this Village of Beecher, Will County, Illinois, having reviewed the current provisions of the Zoning Ordinance, the Planning and Zoning Commission findings of fact, and the Petitioner's request, now finds that its approval of this Application would not be inconsistent with surrounding uses nor be contrary to the intent of the Zoning Code of the Village provided certain conditions are met and would be in the best interests of the residents of this Village and the approval of this Application will promote the health, safety, morals and general welfare of this community.

NOW, THEREFORE, BE IT ORDAINED BY THE PRESIDENT AND BOARD OF TRUSTEES OF THE VILLAGE OF BEECHER, WILL COUNTY, ILLINOIS, AS FOLLOWS:

SECTION ONE: After receiving the recommendation for approval from the Planning and Zoning Commission for the Special Use for 759 W. Indiana Avenue, Beecher, Illinois, and confirming that the Special Use otherwise conforms to the applicable regulations of the B-1 Historic Downtown District, the Corporate Authorities of the Village of Beecher, Will County, Illinois, adopt the Findings of Fact made by the Planning and Zoning Commission, a true and correct copy of which is marked as *Exhibit A*, attached hereto and incorporated by reference as if fully set forth herein and additionally find as follows:

- a. The Special Use is deemed necessary for the public convenience at the location;
- b. The Special Use is so designated, located and proposed to be operated that the public health safety and welfare will be protected; and
- c. The Special Use will not cause substantial injury to the value of other property in the neighborhood in which it is located.

SECTION TWO: That the Premises commonly known as 759 W. Indiana Avenue in Beecher are hereby granted a Special Use Permit to operate a U-Haul rental business in a B-1 Historic Downtown District provided the following conditions are maintained:

- A. No more than four (4) trucks to be located on the property at any time; and
- B. Only one (1) truck may be parked in the front of the building at any time and such vehicle must be operational and moved from its location occasionally.
- C. Permanently parked or non-operational vehicles are prohibited from being placed in front of the business from being used for advertising purposes.

SECTION THREE: This Ordinance shall be in full force and effect from and after its passage and approval as provided by law, and is enacted pursuant to the statutory non-Home Rule Authority of the Village of Beecher as granted by 65 ILCS 5/11-13-1, *et seq*.

SECTION FOUR: This Ordinance is subject to change or amendment in accordance with the regular procedures of the Village of Beecher and the owner and the subsequent owners of any property affected by this Ordinance should recognize the right of the Village of Beecher in this regard when contemplating any investment or expenditure of money.

SECTION FIVE: That failure of the owner or other party in interest, or a subsequent owner or other party in interest, to comply with the terms of this Ordinance, after execution of this Ordinance, shall subject the owner or party in interest to the penalties set forth in the Village Zoning Ordinance, and/or termination of the special use after notice and public hearing in accordance with the procedures required by statute and the Village Zoning Ordinance.

	ev. Village Clerk		
ATTEST:		Marcy Meyer,	Village President
Present:			
Abstain:			
Nays:			
Yeas:			

PASSED and **APPROVED** this 26th day of August, 2024.

EXHIBIT A

No Special Use shall be granted by the President and the Board of Trustees unless the Special Use:

- a. Is deemed necessary for the public convenience at the location;

 There was previously a U-Haul rental location within Beecher but is no longer in operation. The closest place for Beecher residents to rent a truck for moving large items is in Monee and/or Crete which can be roughly 15-20 minutes away and add extra mileage and gasoline expense to Beecher residents. The re-establishment of a U-Haul location within Beecher will be a benefit and convenience for Beecher residents and reduce time/costs for Beecher customers.
- b. Is so designated, located and proposed to be operated that the public health, safety and welfare will be protected; and
 - The property owner is proposing to allow for a minimal amount of small trucks to be located on the property (no more than four trucks). The trucks will primarily be parked at the rear of the building and out of site of the general public. Only one truck will be parked in the front of the building for advertising purposes, but will remain operational and not permanently parked in the front of the building. This minimal amount of small truck parking will not have a detrimental effect on the public welfare.
- c. Will not cause substantial injury to the value of other property in the neighborhood in which it is located; and has been recommended by the Planning and Zoning Commission and approved by the President and the Board of Trustees, and conforms, except in the case of a planned development, to the applicable regulations of the district in which it is located.

The subject property is in the historic downtown area and the Village is very concerned with maintaining the character of the area. The proposed rental of no more than four small U-Haul trucks will not have a detrimental effect on neighboring properties. A majority of the trucks will be parked at the rear of the building and out of site. In addition, the truck will be small box truck type vehicles that will not negatively impact roads and other Village infrastructure. In addition, the availability of rental trucks within the Village will be a benefit to local property owners and businesses.

In addition, the Planning and Zoning Commission shall make findings based upon the evidence presented to it in each specific case with respect to the following:

- 1. Compatibility with surrounding land uses and the general area; The property is zoned B-1 Historic Downtown District. The property is surrounded by local businesses. The proposed use will not have a negative impact on surrounding land uses.
- 2. The zoning classification of property with the general area of the property in question; *The property is zoned B-1 Historic Downtown District and consistent with the general area.*

- 3. The suitability of the subject property to the use permitted under the existing zoning classification;
 - The subject property is suitable for a U-Haul business with conditions.
- 4. The trend of development, if any, in the general area of the subject property, including recent changes, if any, which have taken place in its zoning classification; and *The proposed business is consistent with the trend of development in the B-1 Historic Downtown District.*
- 5. The relationship of the existing zoning classification to the Official Comprehensive Plan of Beecher.

The proposed facility is zoned B-1 Historic Downtown District and is consistent with the Village of Beecher Comprehensive Plan.

The Plan Commission recommended approval of the proposed special use to operate a U-Haul rental business at 759 W. Indiana Avenue, subject to the following conditions:

- A. No more than four (4) trucks to be located on the property at any time; and
- B. Only one (1) truck may be parked in the front of the building at any time. In addition, a truck parked in the front of the building must be operational and moved from its location occasionally. Permanently parked or non-operational vehicles are not permitted to be used for advertising purposes.

MEMORANDUM OF UNDERSTANDING BETWEEN THE VILLAGE OF MONEE AND THE VILLAGE OF BEECHER

This Memorandum of Understanding, herein after known as "Agreement" has been entered into as of the 20th day of August 2024 (effective date) by and between the Village of Monee ("Monee") and the Village of Peotone ("Beecher"), sometimes referred to collectively as the Parties.

WHEREAS, Monee and Beecher both have municipal police departments which provide for the safety and security of their residents; and

WHEREAS, the Parties desire to establish a framework by which Beecher can provide protective personnel and equipment to Monee in relation to their function as a municipal police force; and

NOW THEREFORE, in consideration of the foregoing premises and the terms and conditions hereinafter provided, the Parties agree as follows:

Section One. Preambles

That the preambles set forth above are hereby incorporated herein by reference.

Section Two. Additional Police Personnel

Beecher hereby agrees to provide additional police personnel and equipment subject to the terms set forth herein. The Parties shall agree on the times and days of service subject to the sole discretion of the Monee Police Chief and the availability of Beecher personnel and equipment. At no time will Beecher be obligated to provide such personnel which could adversely affect the daily police operations of Beecher.

Section Three. Cost

Monee hereby agrees to reimburse Beecher for all costs incurred as a result of providing police, personnel, and equipment under this agreement. These costs include, but are not limited to, the hourly wages of personnel and all associated cost of employing such personnel (including benefits) equipment expenses, and any additional ancillary expenses as agreed to by the Parties. Beecher shall submit an itemized invoice to Monee monthly and Monee agrees to pay that invoice within thirty (30) days of receipt.

Section Four. Hold Harmless

The Parties agree to hold each other, their officials, officers, agents and employees completely free and harmless and will fully indemnify the other from any and all claims,

demands, causes of action, lawsuits or damages which may arise as a result of providing

the police personnel and equipment as described herein.

Section Five. Term of Agreement

The Parties agree that this Agreement shall become effective as of the effective date of this Agreement and shall continue until amended as described below or as terminated by one or both parties provided that ninety (90) day notice of the intention to terminate this

Agreement is provided to the other party.

Section Six. Miscellaneous

The Parties agree that this Agreement may be amended only by mutual consent of the Parties by means of the same procedure used to adopt this Agreement and authorize its

execution in the first instance.

The Agreement can be signed by executing any number of counterparts with the same

effect as signature on each or upon the same Agreement.

The undersigned represent to each other, that they have the requisite authority to bind each

party to the terms and provisions of this Agreement.

IN WITNESS WHEREOF, the Parties hereto have caused this Memorandum of

Understanding to be executed as of the day and year first written above.

Village of Beecher

By: Terrance Lemming, Chief of Police

Scott Koerner_

Village of Monee

By: Scott Koerner, Chief of Police

Proposal.

K.R.T. CONCRETE

9802 N. 17500 E. Road GRANT PARK, IL 60940 Phone: 815-466-0601 Fax: 815-466-0332

		<u> </u>	
wall Conners (village of Deecher)		708-946-2261	08/21/2024
625 Dixie Hwy.		Public sidewalk program	
CITY, STATE AND ZIP CODE Beecher, II 60401		JOB LOCATION	
ARCHITECT	DATE OF PLANS	mconner@villageofbe	echer.org
We hereby submit specifications and estimates for:			
remove and replace 16 squares of sidewalk measuring 4'x67' at 614 Indiana Ave.			
Remove and replace 58 squares of sidewalk measuring 4'x240' at 529 Miller St.			
Add 2 sections of sidewalk at the High School pickleBall court measuring 6'x6'			
Add a new sidewalk at 708 Gould St. measuring 5'x18'			
Add a new pad for the street light controller at the bridge on penfield and small sliver area between			
existing public sidewalk and curb.			
Remove and replace a 8'x8' section of driveway at 543 Chestnut, remove and replace a section of public sidewalk size 5'x16', and a section of apron size 9'x9'.			
Remove and replace 3 sections of public sidewalk at 252 Pine st. measuring 5'x15'.			
Replace 2 sections of sidewalk at 269 Camden st.			
All public sidewalks will be poured at 5' thick, with 6 bag mix, compacted stone fill, broom finish.			
Driveway at 543 Chestnut will be poured at 6"thick per village codes consisting of 6 bag mix, compacted stone fill broom finish.			
All debris will be hauled away to the village dump at village garage.			
All materials such as concrete and stone will be supplied by the village of beecher.			
The propose hereby to furnish material and labor — complete in accordance with above specifications, for the sum of:			
30 days upon completion of job			dollars (\$ 21,600.00).
Payment to be made as follows: This proposal is a Laborer only proposal, all materials will be furnished by the village of Beecher.			
All wages will be paid per will county prevailing wage rates of \$46.25 per hour			
All material is guaranteed to be as specified. All work to be completed in a workmanlike manner according to standard practices. Any afterestion or deviation from above agestice. Authorized Signature			
tions involving entra costs will be esscuted only upon written orders, and will become an extra charge ever and above the estimate. All agreements centingent upon etribes, accidents or delays beyond our control. Owner to corry fire, termede and other necessary insurance.		Signature Note: This proposal may	
or delays beyond our centrel. Cultar to carry, and, curred Our workers are fully covered by Workmen's Compensation	e lacurence.	withdrawn by us if not accepted wi	thin days.
Acceptance of Broposal — The above prices, specifications			
and conditions are satisfactory and are hereby accepted. You are authorized to do the work as specified. Payment will be made as outlined above. Date of Acceptance:		Signature	
		Signature	